C-4 X-SECTIONS AND DRAINAGE DETAILS LANDSCAPE PLAN

C-6 AEROBIC SEPTIC PLAN

C-7 FIRE TANK PLAN PHASING PLAN

BASIN MAPS **EXISTING CONDITIONS & DEMOLITION PLAN** C-11 IMPAIRED WATER TREATMENT PLAN

INDEX OF DRAWINGS

LOCATION MAP

GENERAL NOTES

THE CONTRACTOR SHALL BE RESPONSIBLE FOR OBTAINING ALL PERMITS FROM THE OWNER PRIOR TO COMMENCEMENT OF CONSTRUCTION AND THOROUGHLY REVIEWING AND UNDERSTANDING ALL PERMIT CONDITIONS. ALL WORK SHALL COMPLY WITH THE REQUIREMENTS THE PERMITS. ANY ADDITIONAL CONSTRUCTION/BUILDING PERMITS REQUIRED TO EXECUTE/COMPLETE THE WORK SHOWN IN THESE DOCUMENTS SHALL BE OBTAINED BY THE CONTRACTOR.

ALL CONSTRUCTION MATERIALS AND METHODS SHALL CONFORM TO THE LATEST EDITION OF HILLSBOROUGH COUNTY LAND DEVELOPMENT CODE AND ALL COUNTY TECHNICAL STANDARDS.

ALL ELEVATION DATA IS BASED ON THE NATIONAL GEODETIC VERTICAL DATUM (NAVD) OF 1988.

THE CONTRACTOR SHALL BE RESPONSIBLE FOR COORDINATING ALL WORK WITH SUBCONTRACTORS AND OTHER PUBLIC OR PRIVATE UTILITIES CONSTRUCTING FACILITIES WITHIN THE PROJECT LIMITS.

THE CONTRACTOR SHALL SOLID SOD ALL SLOPES STEEPER THAN 5:1 AND WITHIN COUNTY/FDOT R/W, AND SEED AND MULCH ALL OTHER AREAS DISTURBED BY CONSTRUCTION. IT IS THE CONTRACTOR'S RESPONSIBILITY TO MAINTAIN SOD/SEED AND MULCH UNTIL STABILIZATION HAS OCCURRED.

CONTRACTOR SHALL CONTACT THE ENGINEER AND/OR OWNER PRIOR TO ANY CONSTRUCTION ACTIVITY THAT MAY DAMAGE OR OTHERWISE AFFECT

EXISTING UNDERGROUND UTILITY LINES SHOWN ON THE DRAWINGS WERE TAKEN FROM RECORD DRAWINGS AND DOCUMENTS FURNISHED BY OTHERS. AND NOT FIELD VERIFIED. THE CONTRACTOR SHALL FIELD VERIFY THE LOCATION OF ALL UNDERGROUND UTILITIES WHICH MAY BE AFFECTED BY THE PROPOSED CONSTRUCTION, PRIOR TO ACTUAL CONSTRUCTION. THE ENGINEER SHALL BE IMMEDIATELY NOTIFIED IF A CONFLICT EXISTS BETWEEN ACTUAL FIELD CONDITIONS AND THESE PLANS. CALL SUNSHINE STATE ONE CALL AT 1-800-432-4770 MIN. 48 HOURS BEFORE DIGGING.

THE CONTRACTOR SHALL COORDINATE ALL CONSTRUCTION, INCLUDING TESTING, WITH ENGINEER AND APPROPRIATE CITY OF CLEARWATER INSPECTORS IN ACCORDANCE WITH HILLSBOROUGH COUNTY REQUIREMENTS.

9. THE CONTRACTOR SHALL BE RESPONSIBLE FOR OBTAINING ANY PERMITS THAT IS NOT PROVIDED BY THE ENGINEER OR OWNER. THESE PERMITS MAY BE ROAD CROSSING, ONSITE PIPING PERMIT, UTILITY, SITE CLEARING, AND ALL PERMITS FROM THE GOVERNMENTAL AGENCIES HAVING JURISDICTION OVER THE PROJECT SITE.

0. THE CONTRACTOR SHALL BE RESPONSIBLE FOR FURNISHING ALL FILED AND ACTUAL INFORMATION TO THE ENGINEER FOR THE PREPARATION OF RECORD DRAWINGS. A MARK-UP "IN RED" SET OF PLANS SHALL BE AVAILABLE AT ALL TIME AT THE CONSTRUCTION SITE. FINAL FIELD CONDITIONS SHALL BE SURVEYED BY A LICENSE SURVEYOR. TEN CERTIFIED AS-BUILT SURVEYS SHALL BE FURNISHED TO THE ENGINEER AFTER THE FINAL INSPECTION.

11. ALL PAVEMENT CUT/FILLING SHALL MEET THE FOLLOWING REQUIREMENTS: A. COMPACTED TO A DENSITY OF NOT LESS THAN 98 % PER

ASTM D 1557-70. B. DENSITY TEST SHALL BE CONDUCTED EVERY 12" OF COMPACTED DEPTH OR AS DIRECTED BY THE ENGINEER.

12. THE INFORMATION PROVIDED IN THESE PLANS IS SOLELY TO ASSIST THE CONTRACTOR IN ASSESSING THE NATURE AND EXTENT OF THE CONDITIONS WHICH MAY BE ENCOUNTERED DURING THE COURSE OF WORK. ALL CONTRACTORS ARE DIRECTED, PRIOR TO BIDDING, TO CONDUCT WHATEVER INVESTIGATIONS THEY MAY DEEM NECESSARY TO ARRIVE AT THEIR OWN CONCLUSIONS REGARDING THE ACTUAL CONDITIONS THAT WILL BE ENCOUNTERED, AND UPON WHICH THEIR BIDS WILL BE BASED UPON.

13. EROSION / SEDIMENTATION CONTROL

CONTRACTOR IS TO PROVIDE EROSION CONTROL/SEDIMENTATION BARRIER (HAY BALES OR SILTATION CURTAIN) TO PREVENT SILTATION OF ADJACENT PROPERTY, STREETS, STORM SEWERS AND WATERWAYS. IN ADDITION CONTRACTOR SHALL PLACE STRAW, MULCH OR OTHER SUITABLE MATERIAL ON GROUND IN AREAS WHERE CONSTRUCTION RELATED TRAFFIC IS TO ENTER AND EXIT THE SITE. IF, IN THE OPINION OF THE ENGINEER AND/OR LOCAL AUTHORITIES, EXCESSIVE QUANTITIES OF EARTH ARE TRANSPORTED OFF-SITE EITHER BY NATURAL DRAINAGE OR VEHICULAR TRAFFIC, THE CONTRACTOR IS TO REMOVE AND CLEAN TO THE SATISAFACTION OF THE ENGINEER AND/OR AUTHORITIES.



CONSTRUCTION PLANS COTTAGES OF HOPE 11404 HOPE INTERNATIONAL DR TAMPA, FL 33625 STR 13/28S/17E FOLIO NO. 003690-0000

PREPARED FOR:

HOPE INTERNATIONAL MINISTRIES INC 11415 HOPE INTERNATIONAL DR, TAMPA, FL 33625-3963

LEGAL DESCRIPTION

THE EAST $\frac{1}{4}$ OF THE NORTHWEST $\frac{1}{4}$ OF THE NORTHWEST $\frac{1}{4}$, LESS THE

SOUTH 25 FEET THEREOF, AND THE NORTH ¹/₂ OF THE WEST ¹/₂ OF THE

EAST $\frac{1}{2}$ OF THE NORTHWEST $\frac{1}{4}$ OF THE NORTHWEST $\frac{1}{4}$ OF SECTION 13, TOWNSHIP 28 SOUTH, RANGE 17 EAST, HILLSBOROUGH COUNTY,

THE WEST $\frac{3}{4}$ OF THE NORTHEAST $\frac{1}{4}$ OF THE NORTHWEST $\frac{1}{4}$ OF SECTION 13.

FLORIDA; LESS THE SOUTH 25 FEET THEREOF, AND LESS THE NORTH 15

TOWNSHIP 28 SOUTH, RANGE 17 EAST, HILLSBOROUGH COUNTY,

FEET OF THE WEST $\frac{1}{2}$ OF THE EAST $\frac{1}{2}$ OF THE NORTHEAST $\frac{1}{4}$ OF THE

NORTHWEST ¹/₄ OF SECTION 13, TOWNSHIP 28 SOUTH, RANGE 17 EAST.

LEGAL DESCRIPTION: (OVERALL PARCEL)

HILLSBOROUGH COUNTY, FLORIDA.

SITE PREPARATION AND EARTHWORK NOTES

CONTRACTOR SHALL PROVIDE SHORING. SHEETING. AND BRACING AS MAY BE NECESSARY TO PROPERLY ACCOMPLISH THIS WORK. UNDERGROUND UTILITIES TO REMAIN FROM DAMAGE. SHOULD ANY UTILITIES BE ENCOUNTERED THAT ARE NOT INDICATED ON THE PLANS NOTIFY THE OWNER'S REPRESENTATIVE.

a) DISPOSAL: SURPLUS MATERIAL FROM EXCAVATIONS, TRASH, DEBRIS AND MATERIALS RESULTING FROM CLEARING, GRUBBING, AND OTHER OPERATIONS SHALL BECOME THE PROPERTY OF CONTRACTOR AND SHALL BE DISPOSED OF BY REMOVING FROM THE SITE.

b) CLEARING AND GRUBBING: CLEAR AND GRUB TO REMOVE STUMPS, ROOTS, TREES, VEGETATION, ORGANIC MATERIALS, EXISTING PAVEMENT, STRUCTURES AND OTHER OBSTRUCTIONS TO THE WORK. ALL ORGANIC SOILS OR MUCK SHALL BE REMOVED AND BACKFILLED WITH SUITABLE

STRIP THE TOPSOIL FROM ALL AREAS WITHIN THE LIMITS OF CLEARING AND GRUBBING AND STOCKPILE ON THE SITE. TOPSOIL MAY BE SPREAD OVER AREAS OUTSIDE BUILDING AND PAVING LINES UPON COMPLETION

GRADE THE SITE TO THE FINISHED CONTOURS INDICATED. IMMEDIATELY BEFORE REQUESTING FINAL INSPECTIONS. CHECK THE LINES AND DRESS TO THE PROPER CONTOURS. ALL AREAS ARE TO BE STABILIZED. THESE AREAS ARE TO BE MAINTAINED UNTIL ACCEPTANCE BY OWNER. WHEN SOD, PLANT BEDS, GRAVEL AREAS AND THE LIKE ARE INDICATED ON LANDSCAPE DRAWINGS OR SPECIFIED, MAKE ALLOWANCES WHEN ROUGH GRADING FOR THE FINISHED GRADES IN THESE

a) BORROW: SUITABLE EXCAVATED MATERIAL, AS DETERMINED BY THE OWNER'S REPRESENTATIVE, MAY BE USED FOR GRADING. PROCURE ADDITIONAL MATERIALS, WHERE NECESSARY, FROM BORROW PITS APPROVED BY THE OWNER'S REPRESENTATIVE AND FURNISH AT NO ADDITIONAL COST TO THE OWNER. BORROW MATERIALS SHALL HAVE PLASTIC INDEX OF SIX (6) OR LESS WITH A MAXIMUM OF 20 PERCENT PASSING A 200 SIEVE.

b) COMPACTION: AREAS OUTSIDE OF BUILDING AND PAVING LINES SHALL BE COMPACTED TO 90 PERCENT OF MAXIMUM DENSITY (ASSHTO T-180) AT OPTIMUM MOISTURE (ASTM D 1556).

PAVING AND DRAINAGE **CONSTRUCTION NOTES**

REPORT OF SUBSURFACE CONDITIONS

A COPY OF THE SOILS INVESTIGATIONS REPORT IS AVAILABLE FROM TAMPA CIVIL DESIGN LLC., TELEPHONE NUMBER (727) 487-3497

THE ENGINEER DISCLAMS ALL RESPONSIBILITY FOR FINDINGS AND INTER-CONTRACTOR SHALL MAKE WHATEVER SUBSURFACE INVESTIGATIONS HE DEEMS

THE CONTRACTOR WILL PAY FOR ALL TEST REQUIRED BY HILLSBOROUGH COUNTY EXCEPT THOSE PROVING SATISFACTORY OPERATION OF ALL INSTALLED EQUIPMENT. PRESSURE AND LEAKAGE TEST, AND BACTERIOLOGICAL TESTS, FOR PIPE, STRUCTURES, AND ASPHALTIC MATERIALS. THE MANUFACTURER'S OR SUPPLIER'S CERTIFICATE THAT THE MATERIALS MEET THE REQUIREMENTS OF THE OWNER'S REPRE SENTATIVES. ANY TESTS WHICH HAVE TO BE MADE BECAUSE OF THE FAILURE OF INSTALLED MATERIALS TO MEET SPECIFICATIONS SHALL BE PAID FOR BY THE CONTRACTOR AND COSTS OF ANY SUCH TESTS SHALL BE DEDUCTED FROM

AND AS MAY BE REQUIRED BY THE APPROPRIATE GOVERNMENTAL AGENCY HAVING JURISDICTION. THE REQUIRED MATERIALS TESTING IS SUMMARIZED HEREIN ON THE ATTACHED TABLE FOR THE SUBCONTRACTOR TO ENSURE THAT THE REQUIRED TESTING HAS BEEN MADE PRIOR TO COVERING UP ANY OF THE

NECESSARY TO SATISFY HIMSELF AS TO THE ACTUAL FIELD CONDITIONS.

PAYMENTS DUE THE CONTRACTOR.

THE OWNER WILL RETAIN A CERTIFIED ENGINEERING TESTING LABORATORY TO PERFORM ALL MATERIALS TESTING SPECIFIED IN THE TECHNICAL SPECIFICATION

PREPARED BY

TAMPA CIVIL DESIGN

PO BOX NO. 1787 LUTZ, FL 33548-1787 (727) 487-3497 PHONE (813) 482-9128 FAX

CIVIL ENGINEER: HOPE INTERNATIONAL MINISTRIES INC TAMPA CIVIL DESIGN 11415 HOPE INTERNATIONAL DR, PO BOX NO. 1787 TAMPA, FL 33625-3963 LUTZ, FL 33548-1787 (813) 961-1214 (727) 487-3497 CONTACT: DR. MIKE HIGGINS CONTACT: JEREMY COUCH, P.E. SMITH SURVEYORS THE FECHTEL COMPANY 1406 WEST LINEBAUGH AVE 3036 WEST BEARSS AVENUE TAMPA, FL 33612 TAMPA, FL 33618 CONTACT: JOE HANLON (813) 264-7778 CONTACT: JAY FECHTEL


	EXISITNG	PROPOSED	<u>TOTAL</u>
TOTAL AREA	(45.16 AC) 1,967,169 SI	-	
PROJECT AREA —— 477,	173 SF (10.96AC) ——		477,173 SF (100%)
BUILDING AREA ————	7,825 SF ———	22,680 SF ———	30,505 SF (6.39%)
PERVIOUS AREA ————	467,573 SF ———	0 SF ———	374,092 SF (78.40%)
PAVEMENT AREA ————	1,775 SF ————	35,596 SF———	37,371 SF (7.83%)
POND AREA ————	0 SF	35,205 SF———	35,205 SF (7.38%)
ZONING —	PD-H		PD-H 89-43
LAND USE —	CHILDRENS HOME (NO	ON PROFIT SERVICE)	
DATUM —	NAVD 1988		

LEGAL DESCRIPTION

LIMITS OF PROJECT AREA

LEGAL DESCRIPTION: (OVERALL PARCEL) THE EAST $\frac{1}{4}$ OF THE NORTHWEST $\frac{1}{4}$ OF THE NORTHWEST $\frac{1}{4}$, LESS THE SOUTH 25 FEET THEREOF, AND THE NORTH $\frac{1}{2}$ OF THE WEST $\frac{1}{2}$ OF THE EAST $\frac{1}{2}$ OF THE NORTHWEST $\frac{1}{4}$ OF THE NORTHWEST $\frac{1}{4}$ OF SECTION 13, TOWNSHIP 28 SOUTH, RANGE 17 EAST, HILLSBOROUGH COUNTY,

THE WEST $\frac{3}{4}$ OF THE NORTHEAST $\frac{1}{4}$ OF THE NORTHWEST $\frac{1}{4}$ OF SECTION 13, TOWNSHIP 28 SOUTH, RANGE 17 EAST, HILLSBOROUGH COUNTY, FLORIDA; LESS THE SOUTH 25 FEET THEREOF, AND LESS THE NORTH 15 FEET OF THE WEST $\frac{1}{2}$ OF THE EAST $\frac{1}{2}$ OF THE NORTHEAST $\frac{1}{4}$ OF THE NORTHWEST $\frac{1}{4}$ OF SECTION 13, TOWNSHIP 28 SOUTH, RANGE 17 EAST, HILLSBOROUGH COUNTY, FLORIDA.

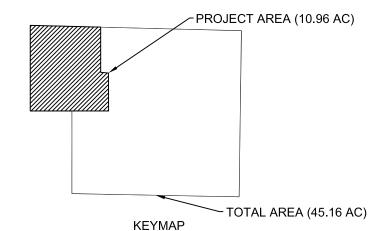




LOCATION MAP

GENERAL NOTES

A) SOLID WASTE CONTINUE IN ONSITE DUMPSTER AREA LOCATED OUTSIDE OF THE DEPICTED PROJECT AREA B) SITE TO BE DEVELOPED WITH SHARED SEPTICS. C) SITE TO BE DEVELOPED WITH SINGLE WELL, LOCATED OUTSIDE OF THE PROJECT AREA. WATER SYSTEM CONSIDERED AS A TRANSIENT NONCOMMUNITY PUBLIC DRINKING WATER SYSTEM PER HILLSBOROUGH COUNTY HEALTH DEPARTMENT CRITERIA. D) ALL STRUCTURES HAVE BEEN PLACED TO HAVE THE


MINIMUM LAND CONTIGUOUS LAND AREA CONSISTENT WITH THE SPACING REQUIREMENTS PER ZONING CONDITION 5, RZ 89-43


E) MAXIMUM STRUCTURE HEIGHT IS 30' F) COTTAGES WILL HAVE A FUNCTIONAL ATTIC FOR STORAGE

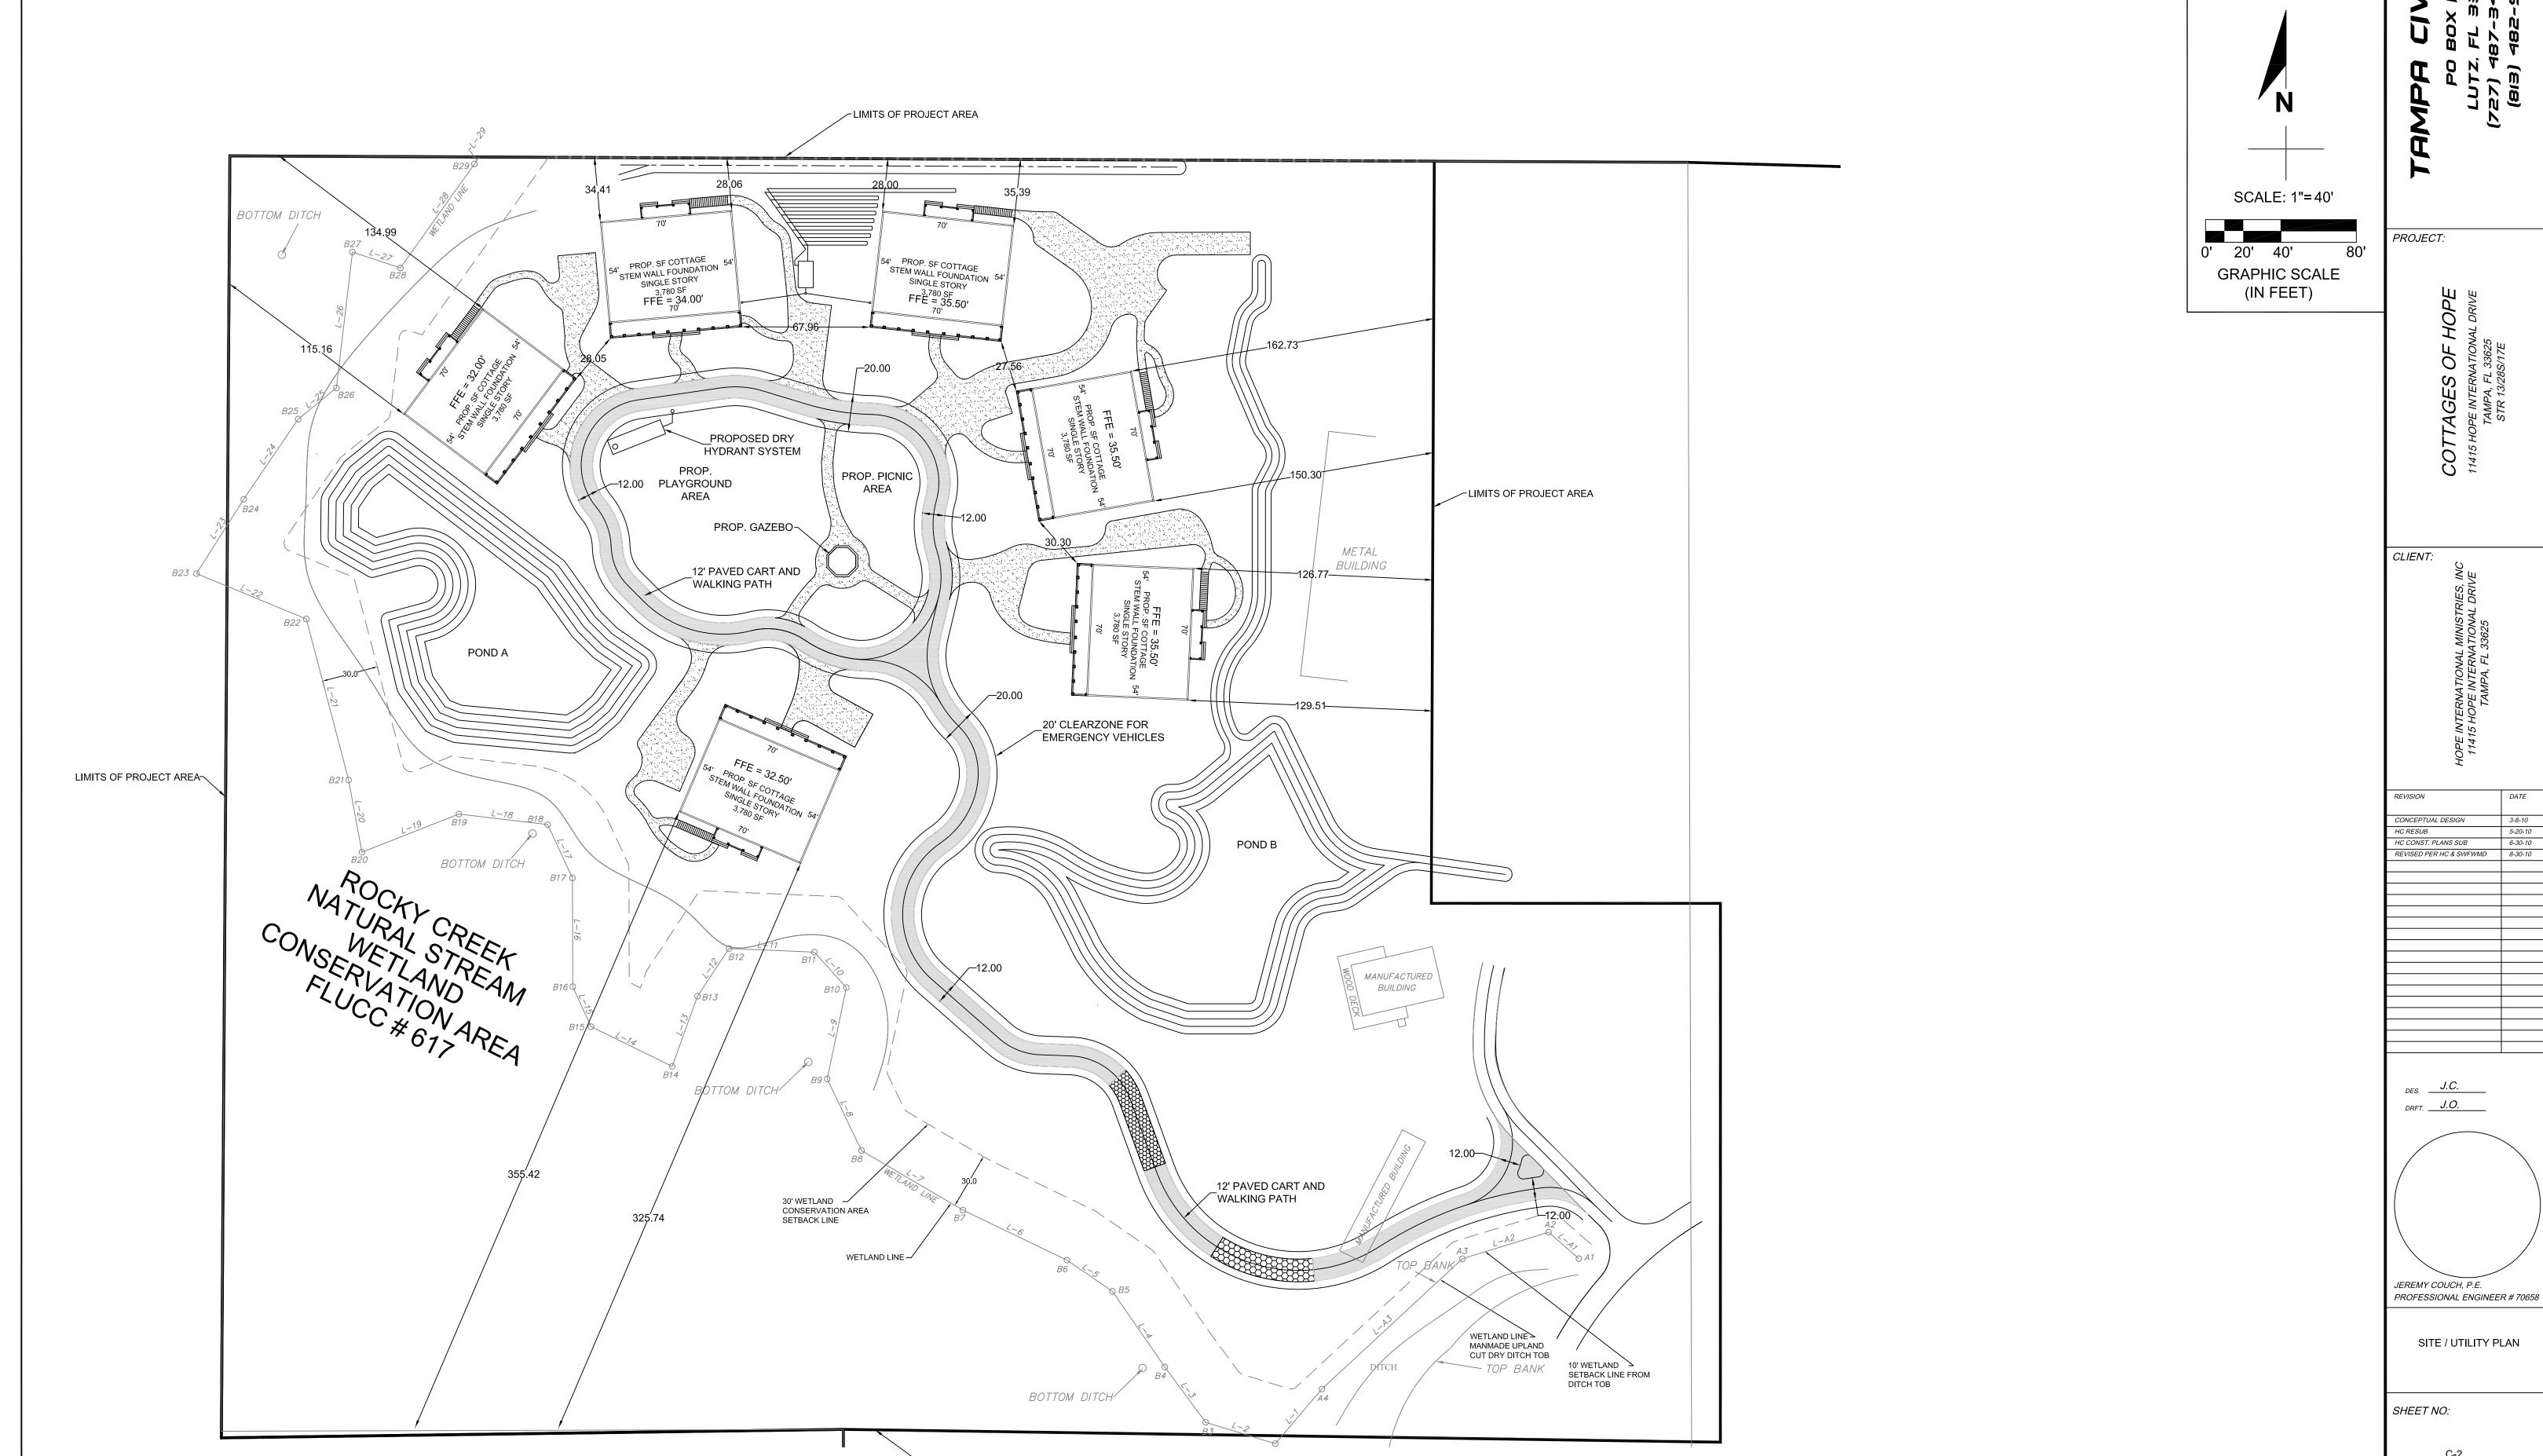



3-8-10


C-2

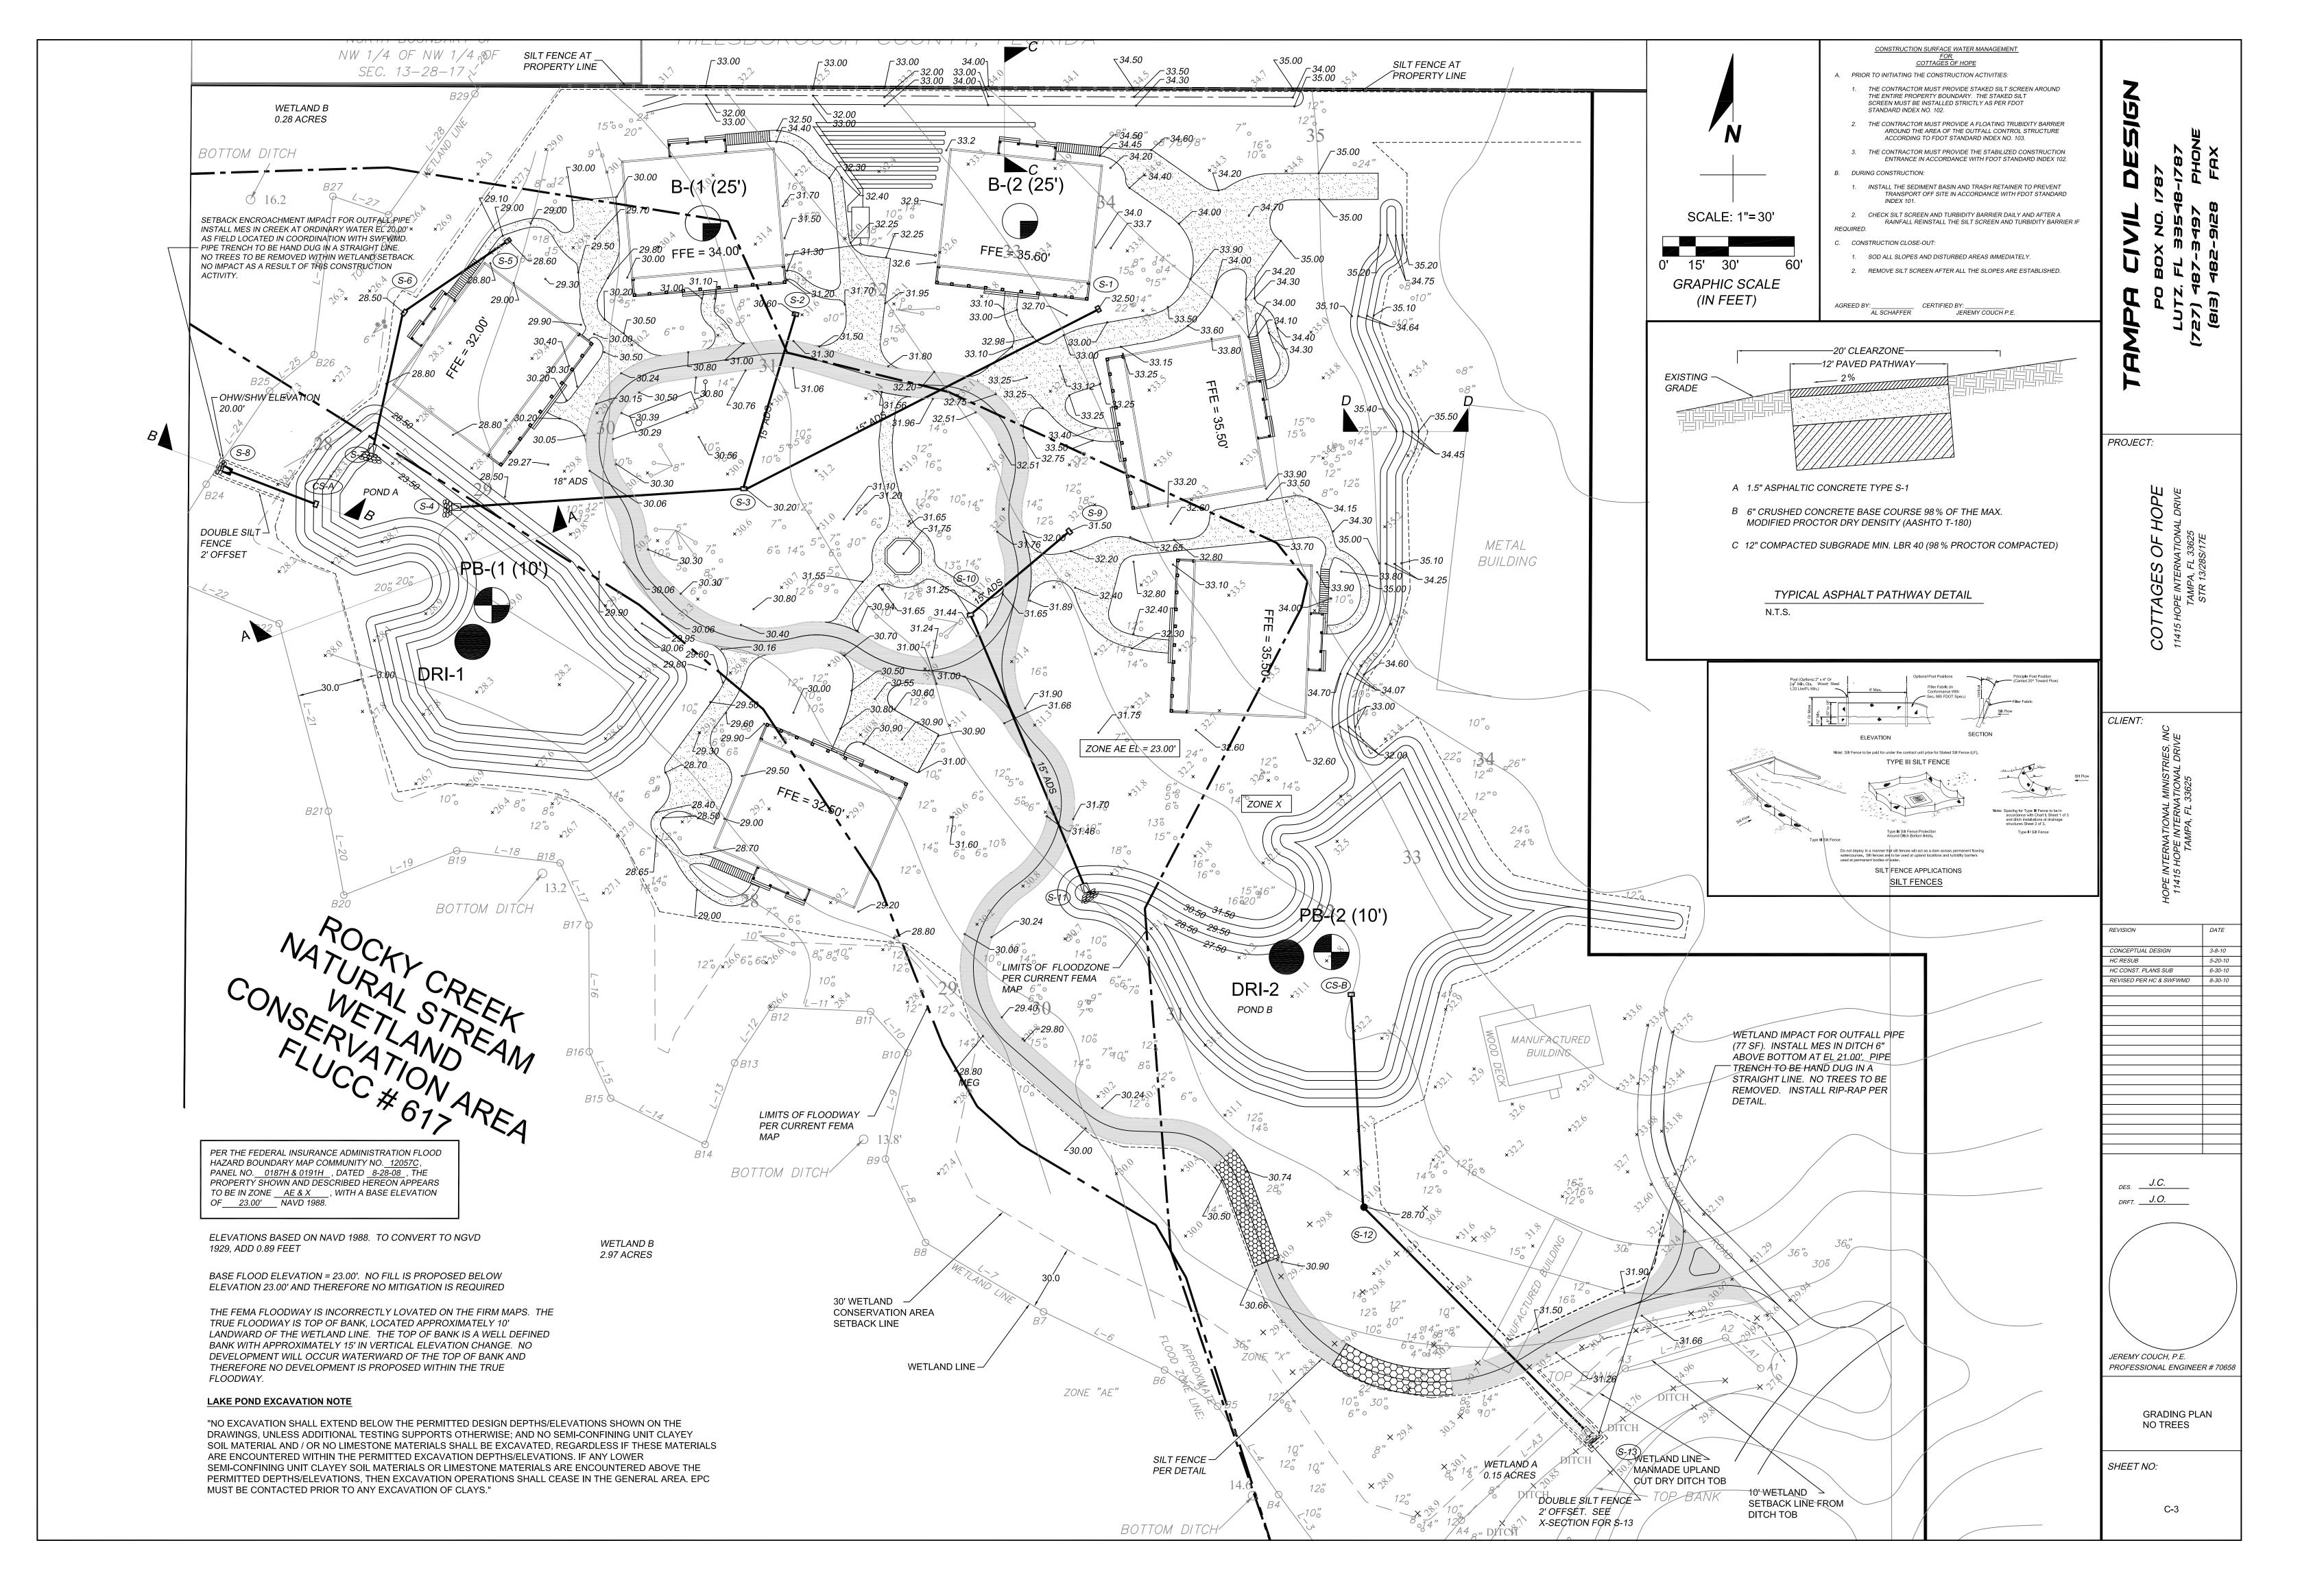

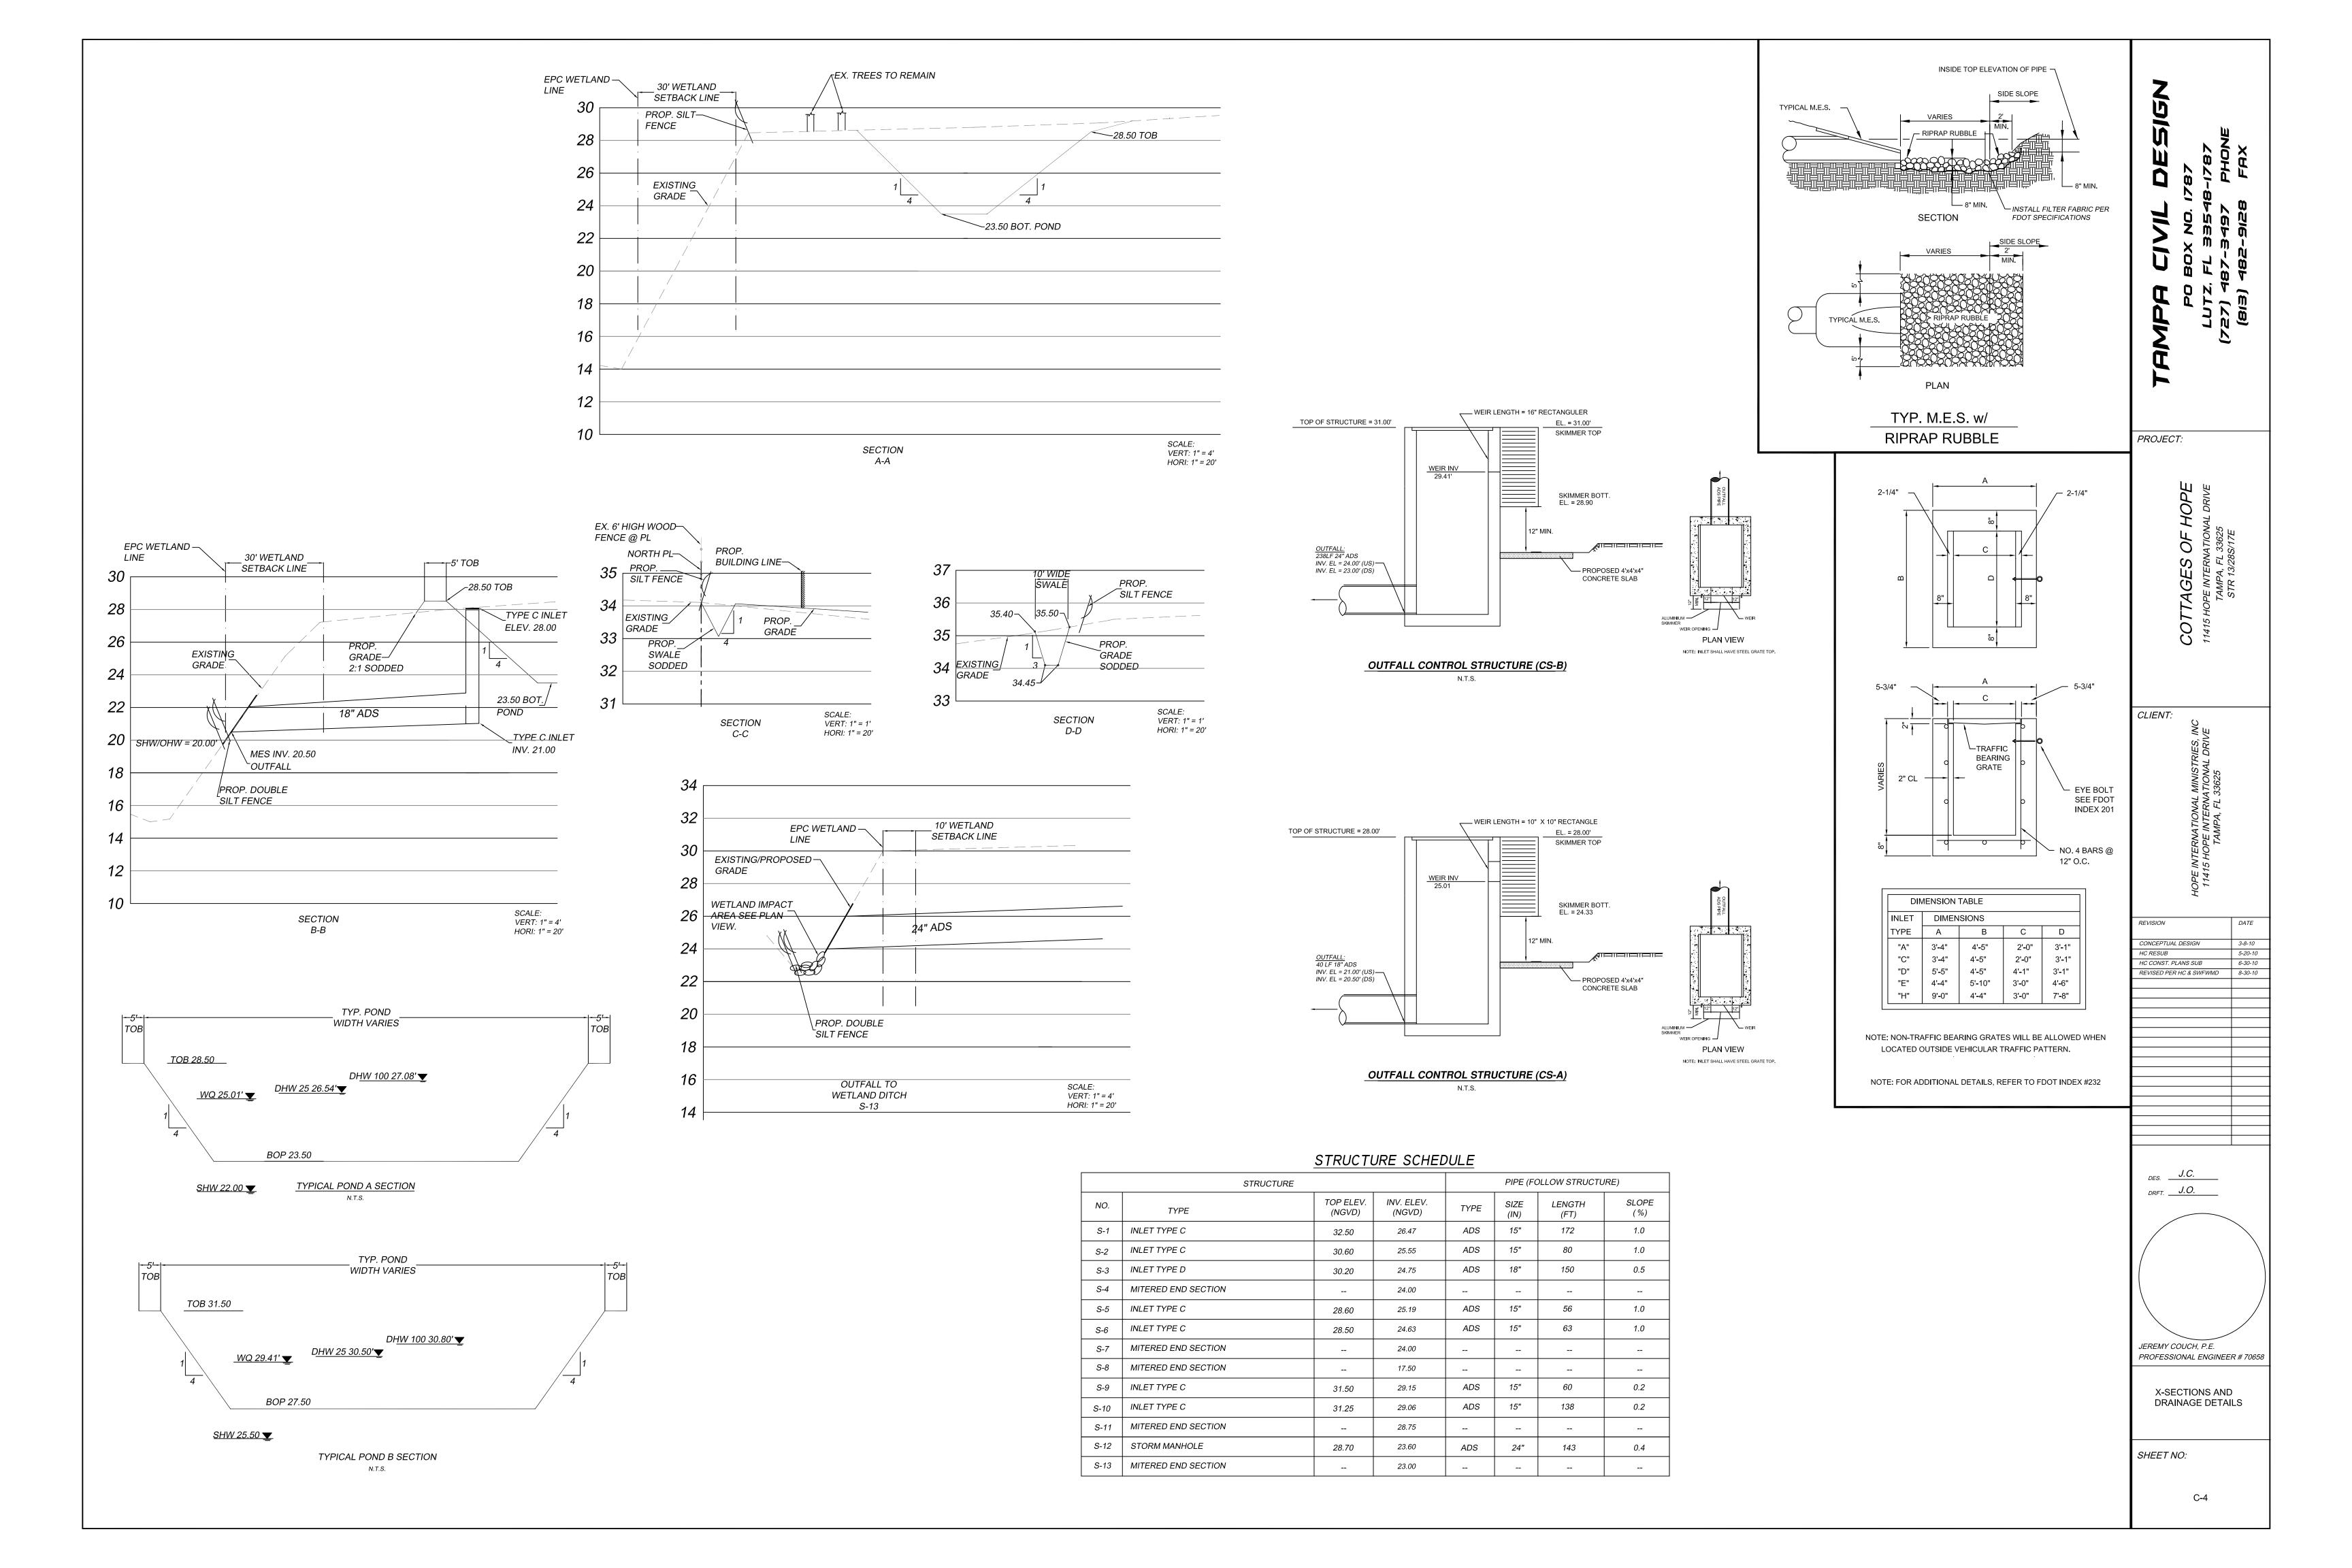

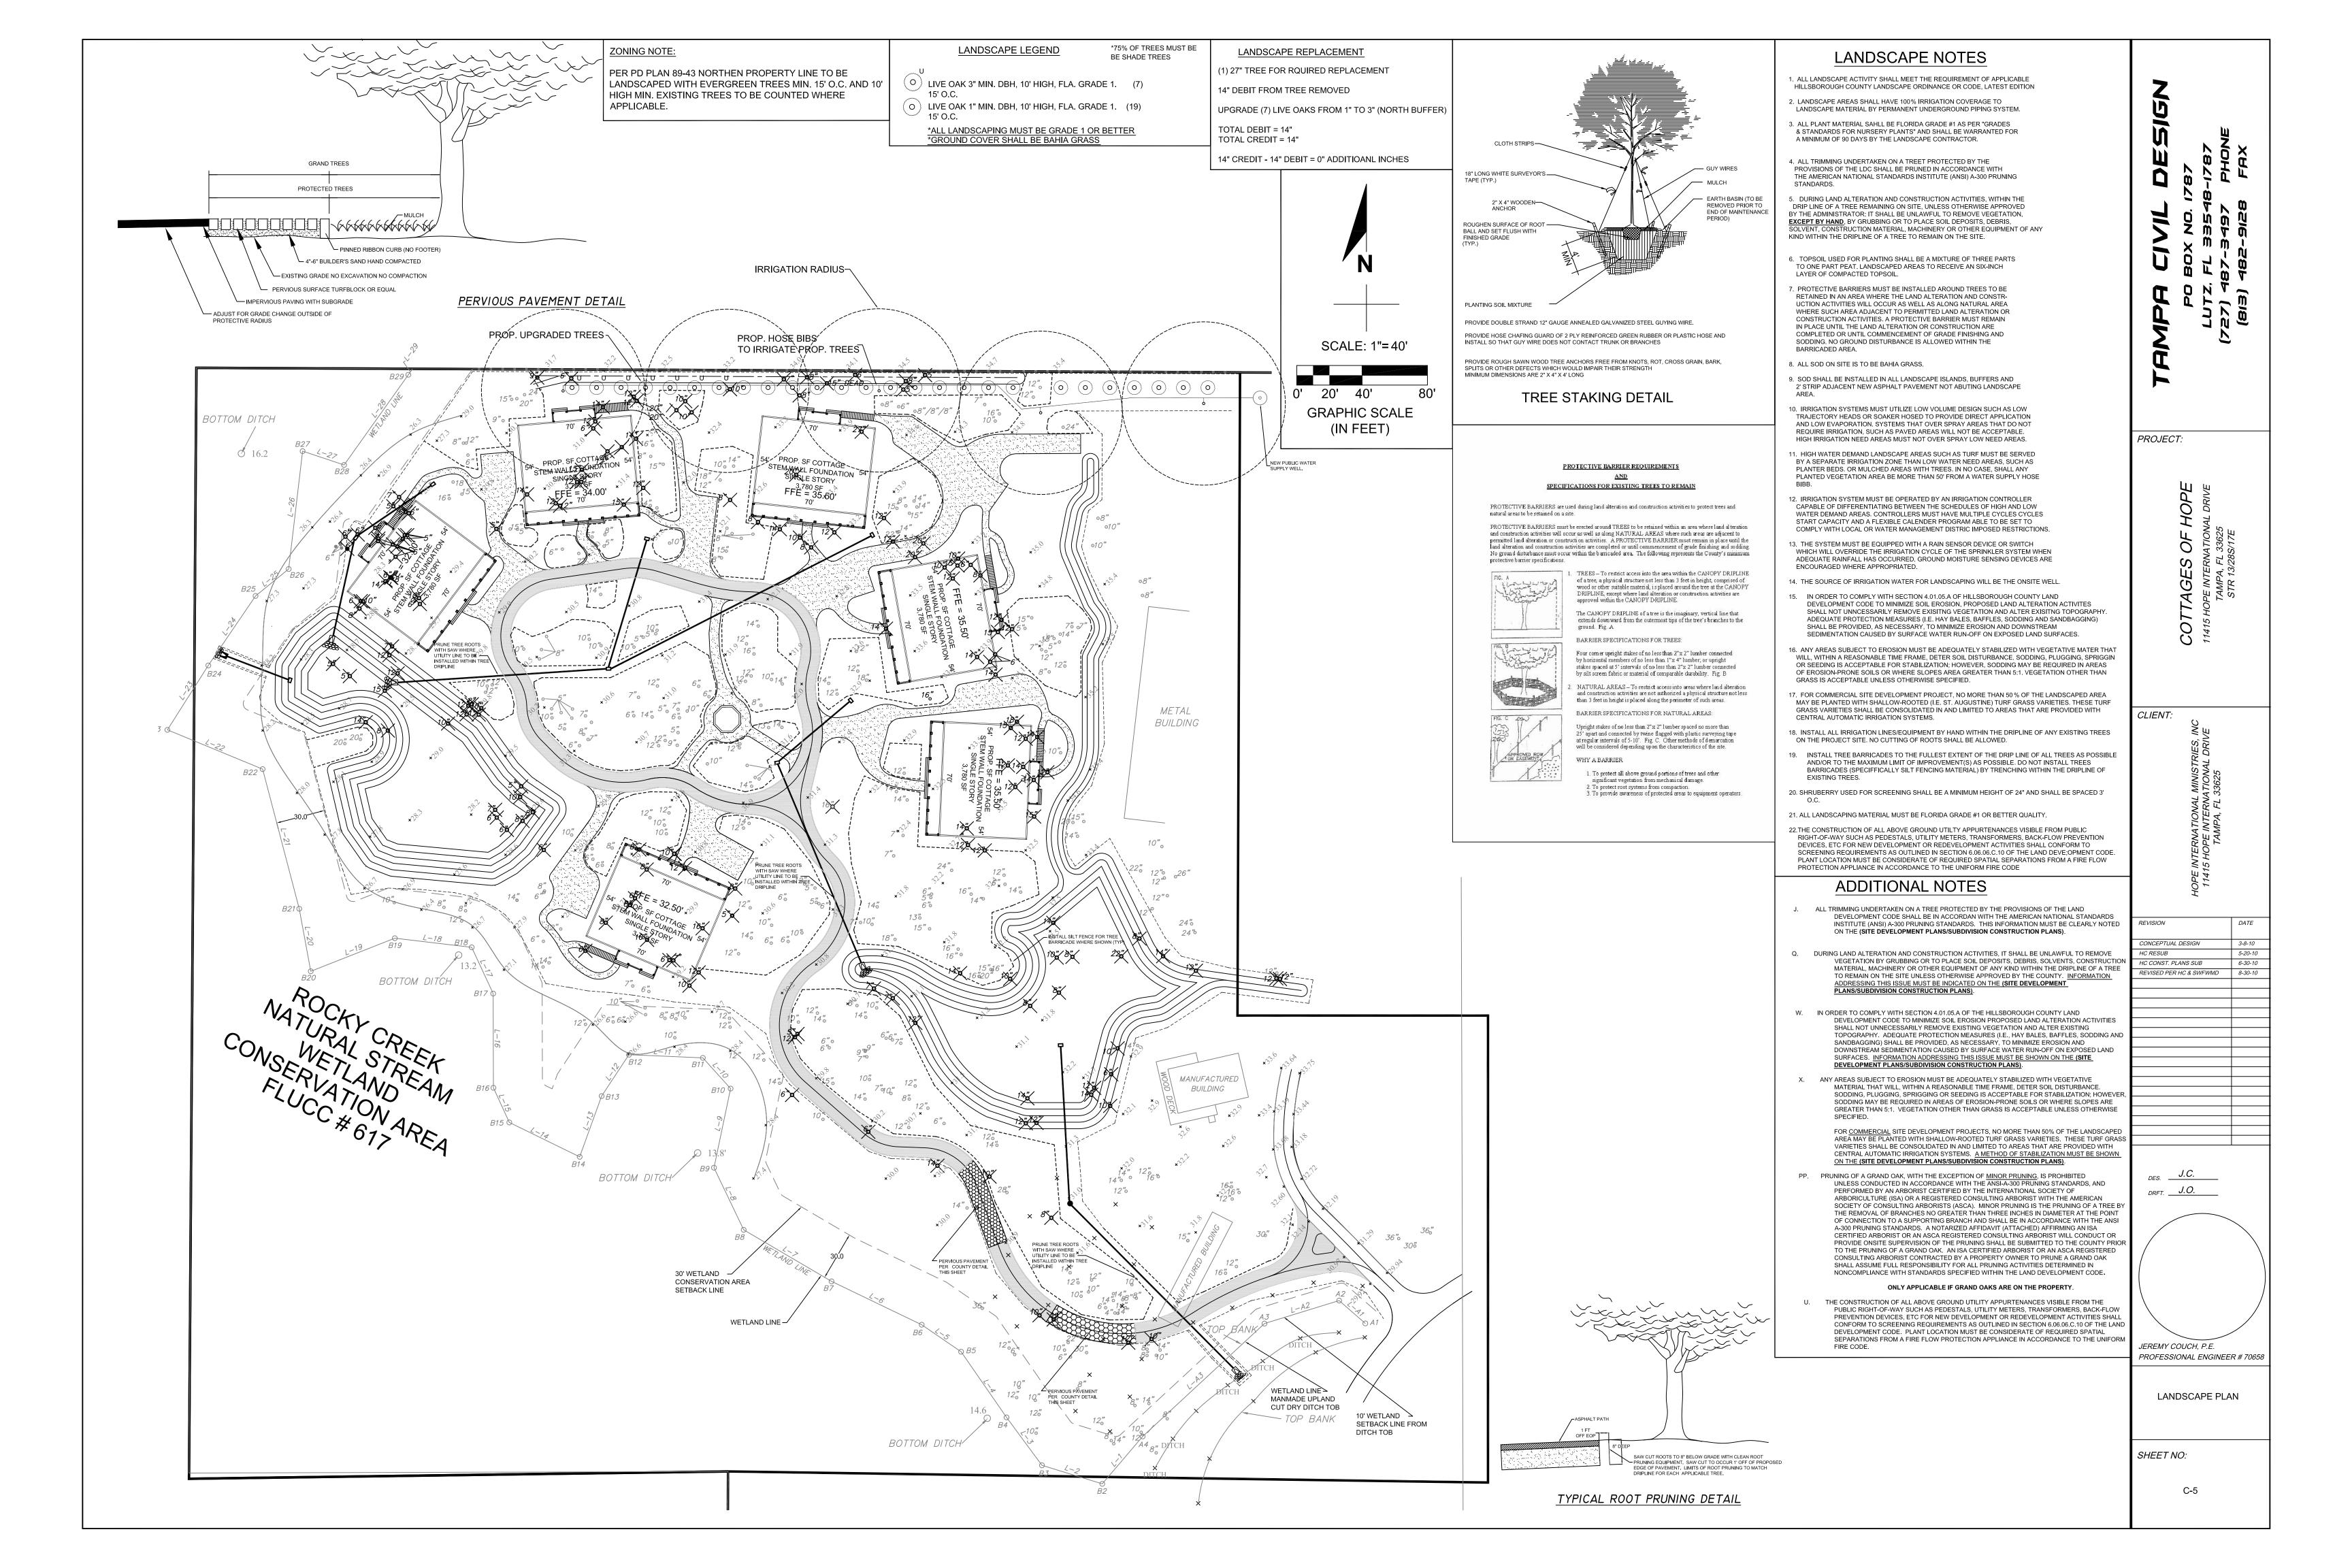

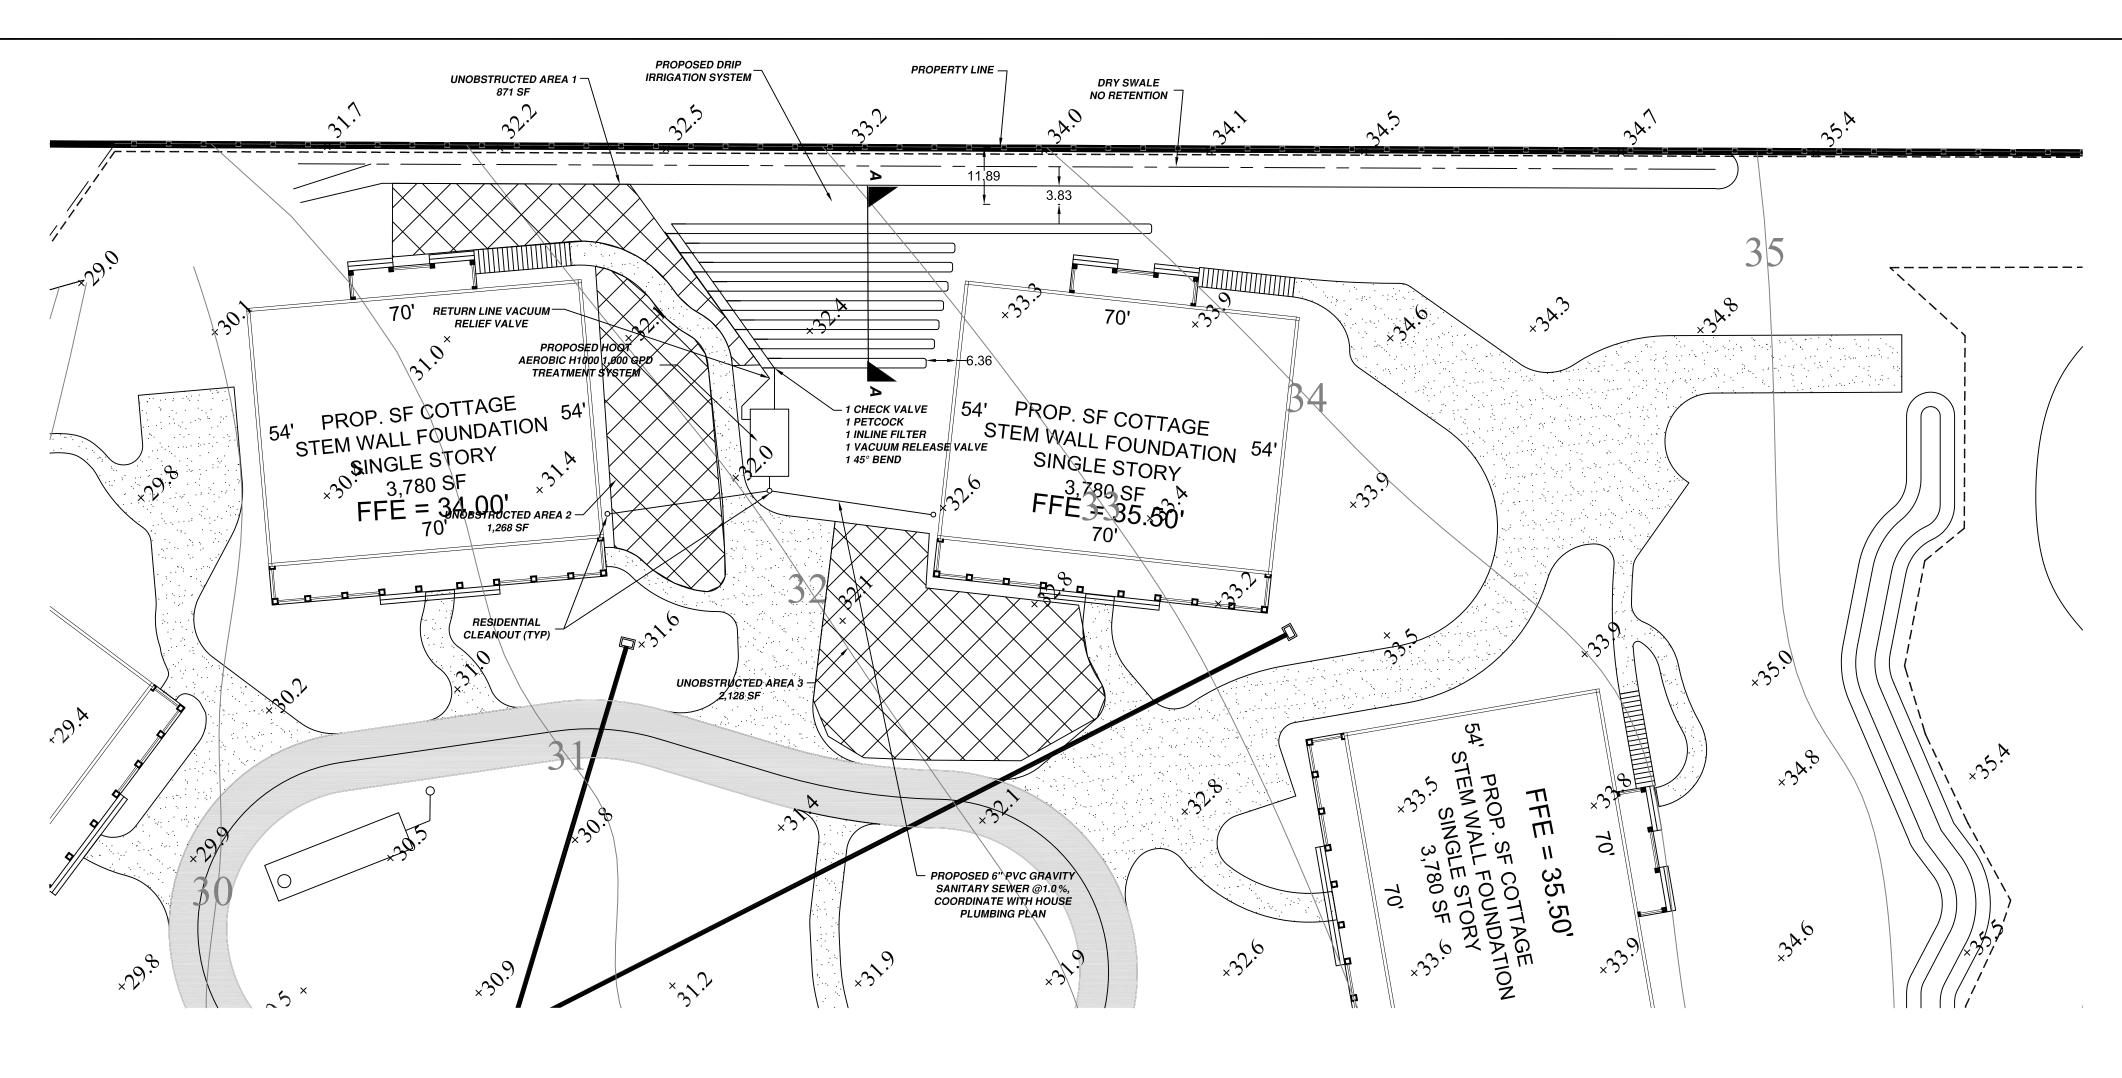


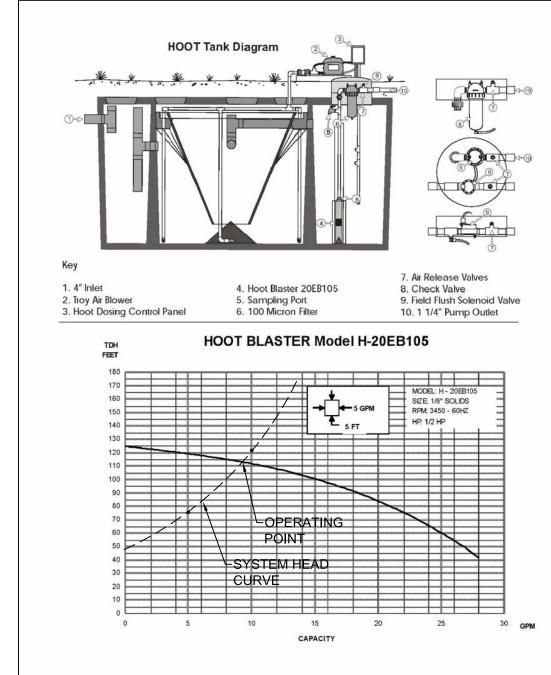

1000 GPD DRIP SYSTEM H-1000 AND

410 Gallons

Rev. 02

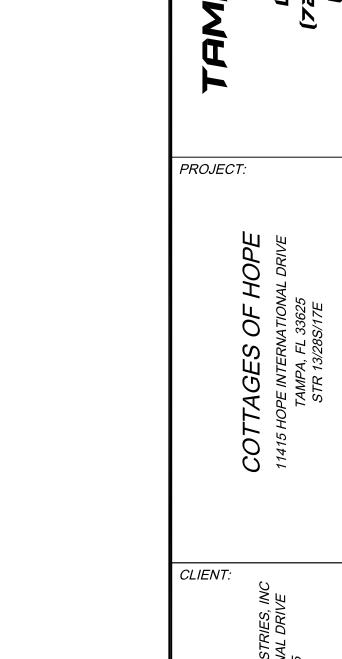

CONCEPTUAL DESIGN

HC CONST. PLANS SUB REVISED PER HC & SWFWMD

C-6

HC RESUB

3-8-10

SCALE: 1"= 20'

GRAPHIC SCALE

(IN FEET)


0' 10' 20'

GENERAL SPECIFICATIONS/NOTES

- 1. If the contractor, in the course of the work, finds any discrepancy between the drawings and the physical conditions of the locality, or any error or omissions in the drawings or in the layout as given by points and instructions, or discovers unforeseen underground or aboveground conditions or any other unexpected conditions requiring additional work by the contractor, it shall be his duty to immediately inform the engineer, in writing, and the engineer shall promptly check the accuracy of the information. Any work done after such discovery, until any necessary changes are authorized, will be done at the contractor's risk.
- 2. If any part of the contractor's work depends, for proper execution or results, upon the work of any other contractor, the contractor shall inspect and measure work already in place and shall at once report to the engineer any discrepancies between the executed work and the drawings.
- 3. The engineer or his authorized representative shall have free access to the work of the contractor at any time for purpose of inspection. The contractor shall furnish the facilities to determine, as best as can reasonably be done, the nature and quality of the work performed. Such assistance of the contractor shall, if necessary, include the uncovering, testing or removal of portions of finished work.
- 4. Debris Removal: All debris shall be removed from the area and legally disposed. Debris may be burned upon obtaining proper burning permit but any unburned remains are to be disposed of as directed by the owner or his representatives.
- 5. The contractor shall be responsible for protecting all buildings, structures, and utilities that are underground, above ground, or on the surface against construction operations that may be hazardous to said facilities and shall hold and save the owner harmless against all claims of damage.
- 6. The contractor shall, by repair or replacement, return to equal or better condition, all pavement, sidewalk, lawns, utilities, and other items damaged by this construction
- 7. The contractor shall be responsible for obtaining all required tests and shall submit reports by an independent testing laboratory approved by the engineer. Should any tests fail to meet specification as shown herein, the contractor shall at his expense correct all deficient work and submit laboratory test results showing compliance with these specifications.
- 8. The contractor shall give the engineer 48 hours notice prior to requesting required inspections and shall supply all equipment necessary to properly test and inspect the completed
- 9. As-builts: The contractor shall complete "as-built" information relative to pipe lengths, materials and any deviation from plans and provide a copy of such to the owner and engineer for final acceptance of the contractor's work.
- 10. Elevations: All elevations refer to NAVD 1988


AEROBIC SYSTEM NOTES:

- 1. TIME DOSING SHOULD OCCUR OVER A 24-HOUR PERIOD.
- 2. SPACING BETWEEN EMMITERS SHALL NOT EXCEED 2FT.
- 3. EMITTER LINES REQUIRE A 2FT MINIMUM SETBACK FROM THE BUILDING AND PROPERTY LINES.
- 4. 18" OF SEPERATION IS REQUIRED BETWEEN THE EMITTER LINES AND THE SHOULDER OF THE FILL.
- 5. ALL DRIP LINES REQUIRE A MINIMUM OF 6" COVER AND A MAXIMUM OF 12".
- 6. LOCATION OF THE PROPOSED HOOT TANK MUST BE 5 FT MINIMUM OFF BUILDING AND PROPERTY LINE.
- 7. ALL AEROBIC SYSTEMS SHALL BE MAINTAINED BY A LICENSED CONTRACTOR IN ACCORDANCE WITH CHAPTER 64E-6, F.A.C.
- 8. CHECK VALVE, INLINE FILTER, PETCOCK AND VACUUM BREAKING DEVICE TO BE INSTALLED AS PER MANUFACTURER.
- 9. DOSING PUMP DISCHARGE LINE SHALL HAVE A PETCOCK FOR SAMPLING PURPOSES.
- 10. POTABLE WATER LINES SHALL BE SLEEVED WHENEVER LESS THAN 10' FROM SEPTIC SYSTEM
- 11. SYSTEM AND ALL COMPONENTS SHALL ONLY BE THOSE APPROVED IN ACCORDANCE WITH F.A.C. 64E.-6.

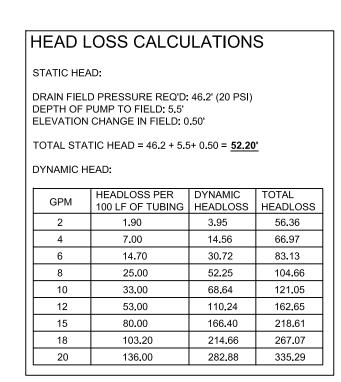

DESIGN FI	LOW: (2) STRUCTURES X 3,780 SF HEATED EA = 1,000 GPD PER CHAPTER 64E-
DRAIN FIE	LD PERMIT REQUIRES = $\frac{1,000 \times 0.75}{0.80}$ = 938
DRAIN FIE	LD REQUIRED = 938 SF
PROPOSE	<u>D</u>
860 LF DR	IP TUBING (430 EMMITTERS X 4SF/EMMITER) = 1,720 SF
1,720 SF >	938 SF <u>OK</u>
DESIGN C	RITERIA
EMITTER I	DISCHARGE = 0.92 GAL/HOUR
DOSE PER	RIOD = 15 MIN/DOSE OR 1 DOSE/HR
430 EMMI	TERS PROVIDED
CALCULA	<u>rions</u>
DOSES PE	R DAY:
1 DOSE/H	R x 24 HR = 24 DOSES/DAY
EMITTER I	DOSE CAPACITY:
0.92 GAL/H	HR x 430 EMITTERS x 15 MIN/DOSE x 1 HR/ 60MIN = 98.90 GAL/DOSE
98.90 GAL	/DOSE x 24 DOSE/DAY = 2,374 GPD > 1000 GPD <u>OK</u>
RECIRCUL	ATION RATE:
DESIGN FI	LOW = 9 GPM (SEE OPERATING POINT ABOVE)
TOTAL EM	IITTER FLOW = (0.92 GPH / 60) x 430 EMITTERS = 6.59 GPM
RECIRCUL	ATION RATE = 9 GPM - 6.59 GPM = 2.41 GPM


AEROBIC SYSTEM DESIGN

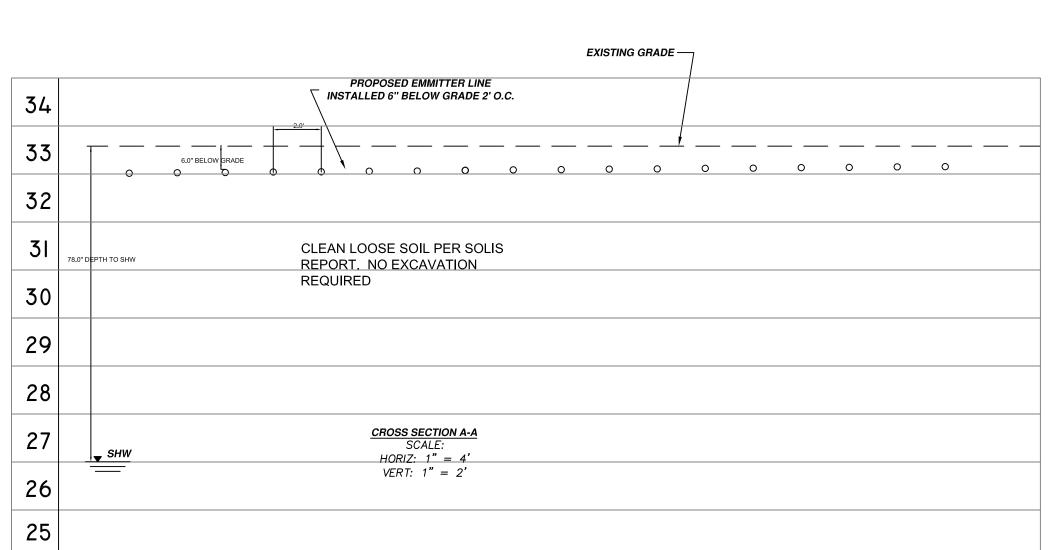


1469 Gallons 339 Gallons Remaining In Tank

1130 Gallons Pumping Capacity

DES. J.C. DRFT. J.O. JEREMY COUCH, P.E. PROFESSIONAL ENGINEER # 70658 AEROBIC SEPTIC PLAN SHEET NO:

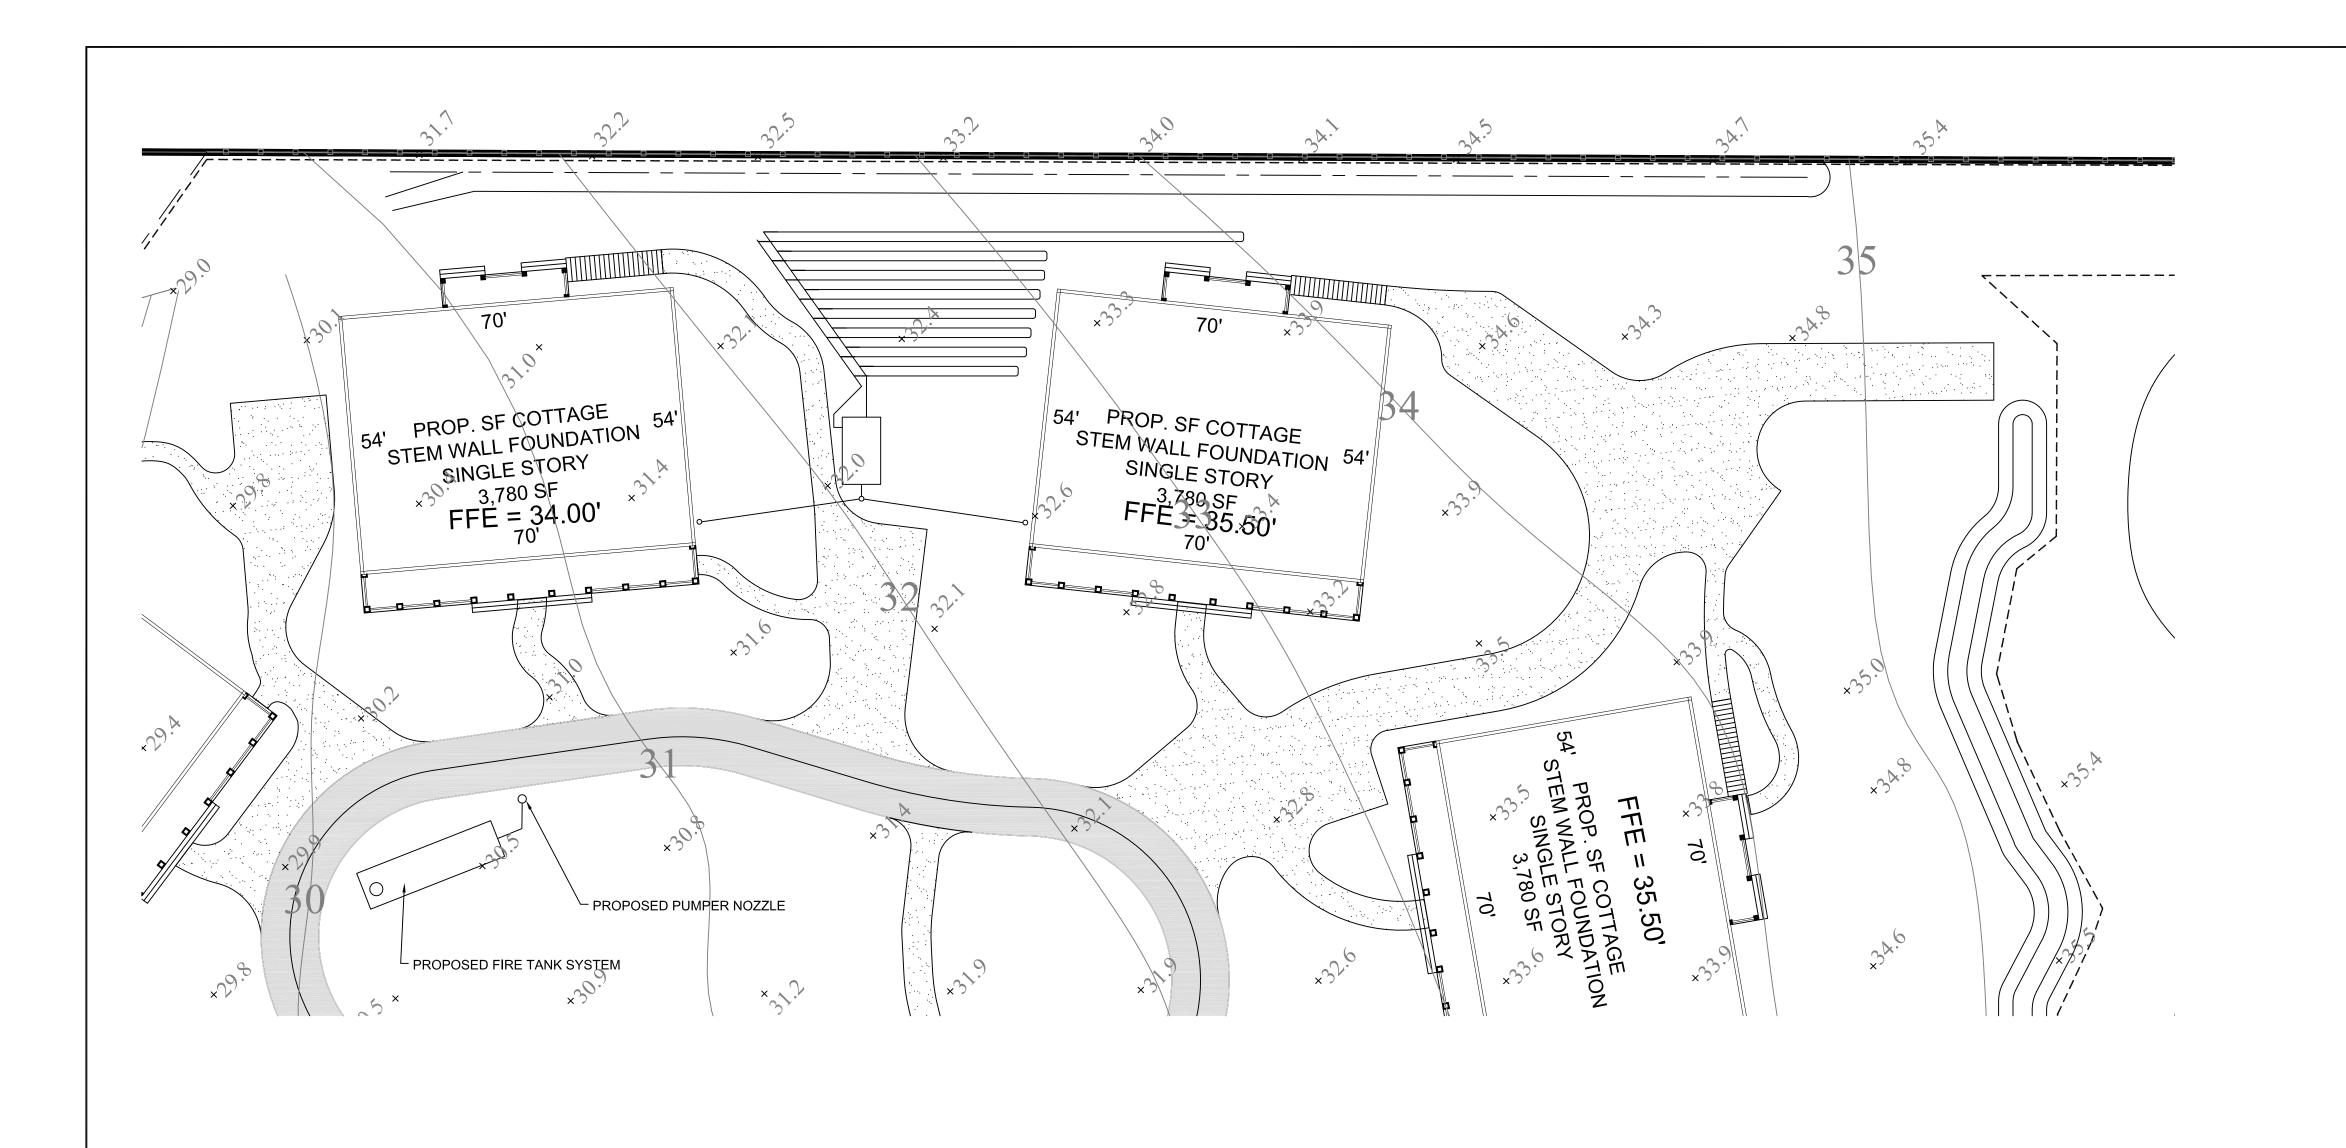

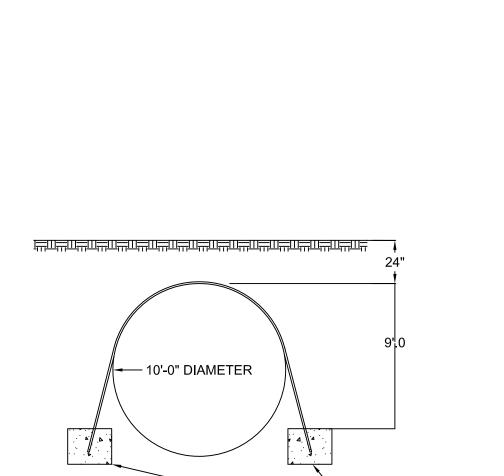

SECTION THRU TANKS

HOPE CHILDRENS HOME FIRE VAULT CALCULATIONS:

∠ 24" X 24" X 24'-0" CONC.DEAD MAN

PROPOSED SINGLE BUILDING

VOLUME REQUIREMENTS:

VStot = 69,000 CF


OHC = 7 per NFPA 1142 STANDARDS, SECTION 5.2.4.2 (DWELLING)
CC = 1.5 per NFPA 1142 STANDARDS, TABLE 6.2.1 (TYPE V)

WSmin = (VStot)(CC)(1.5)/(CC)

WSrequired = (69,000)(1.5)(1.5)/ 7 = 22,179 GAL. REQUIRED

PROPOSED STORAGE TANK

(1) 24,000 GAL OR (2) 12,000 GAL

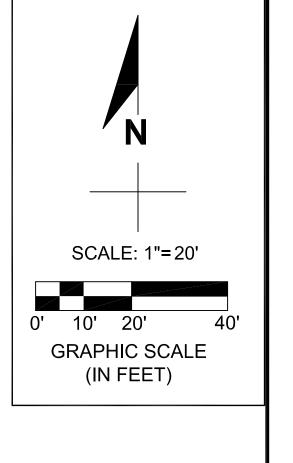

STR 13/28S/17E

 REVISION
 DATE


 CONCEPTUAL DESIGN
 3-8-10

 HC RESUB
 5-20-10

 HC CONST. PLANS SUB
 6-30-10

 REVISED PER HC & SWFWMD
 8-30-10


DES. J.C.

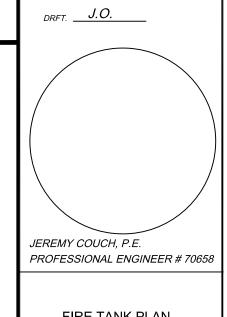



FIRE TANK PLAN

SHEET NO:


C-7

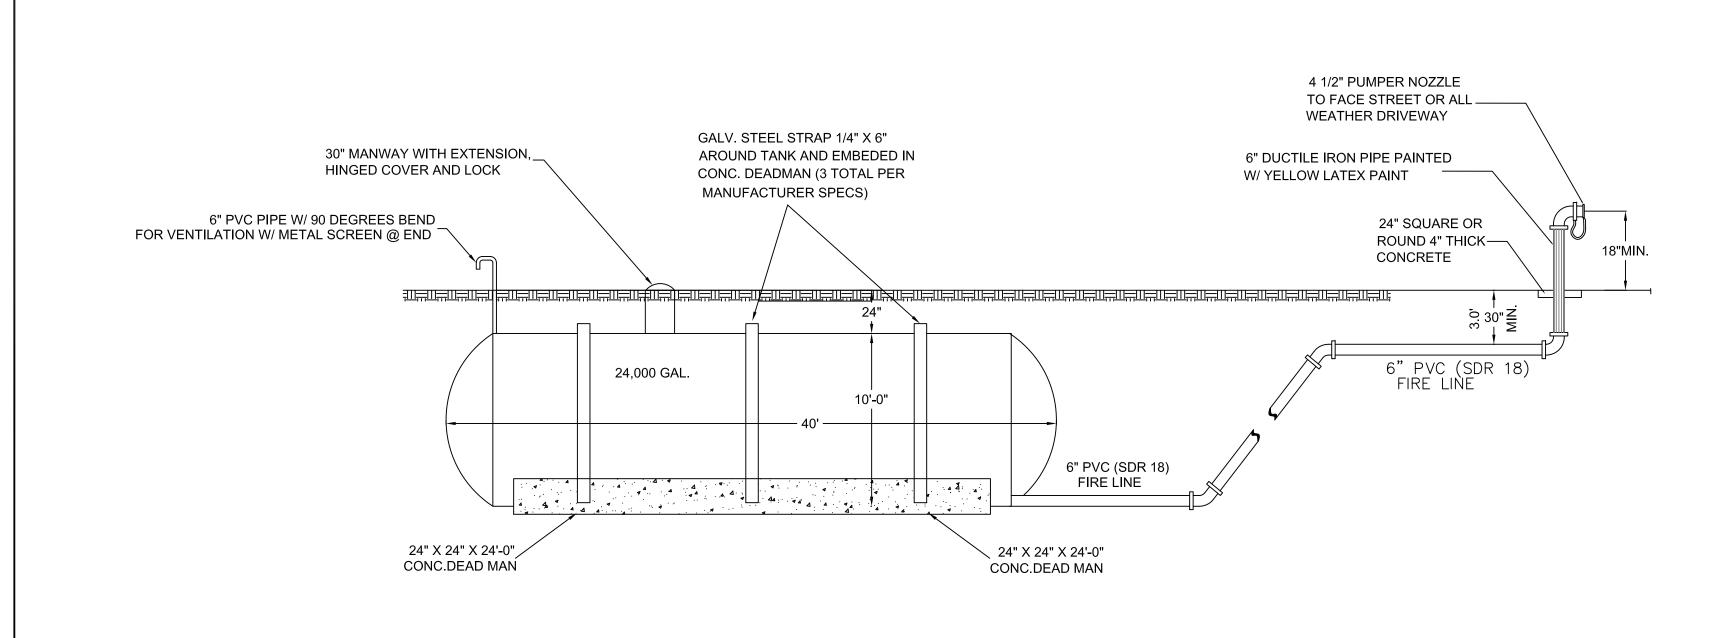


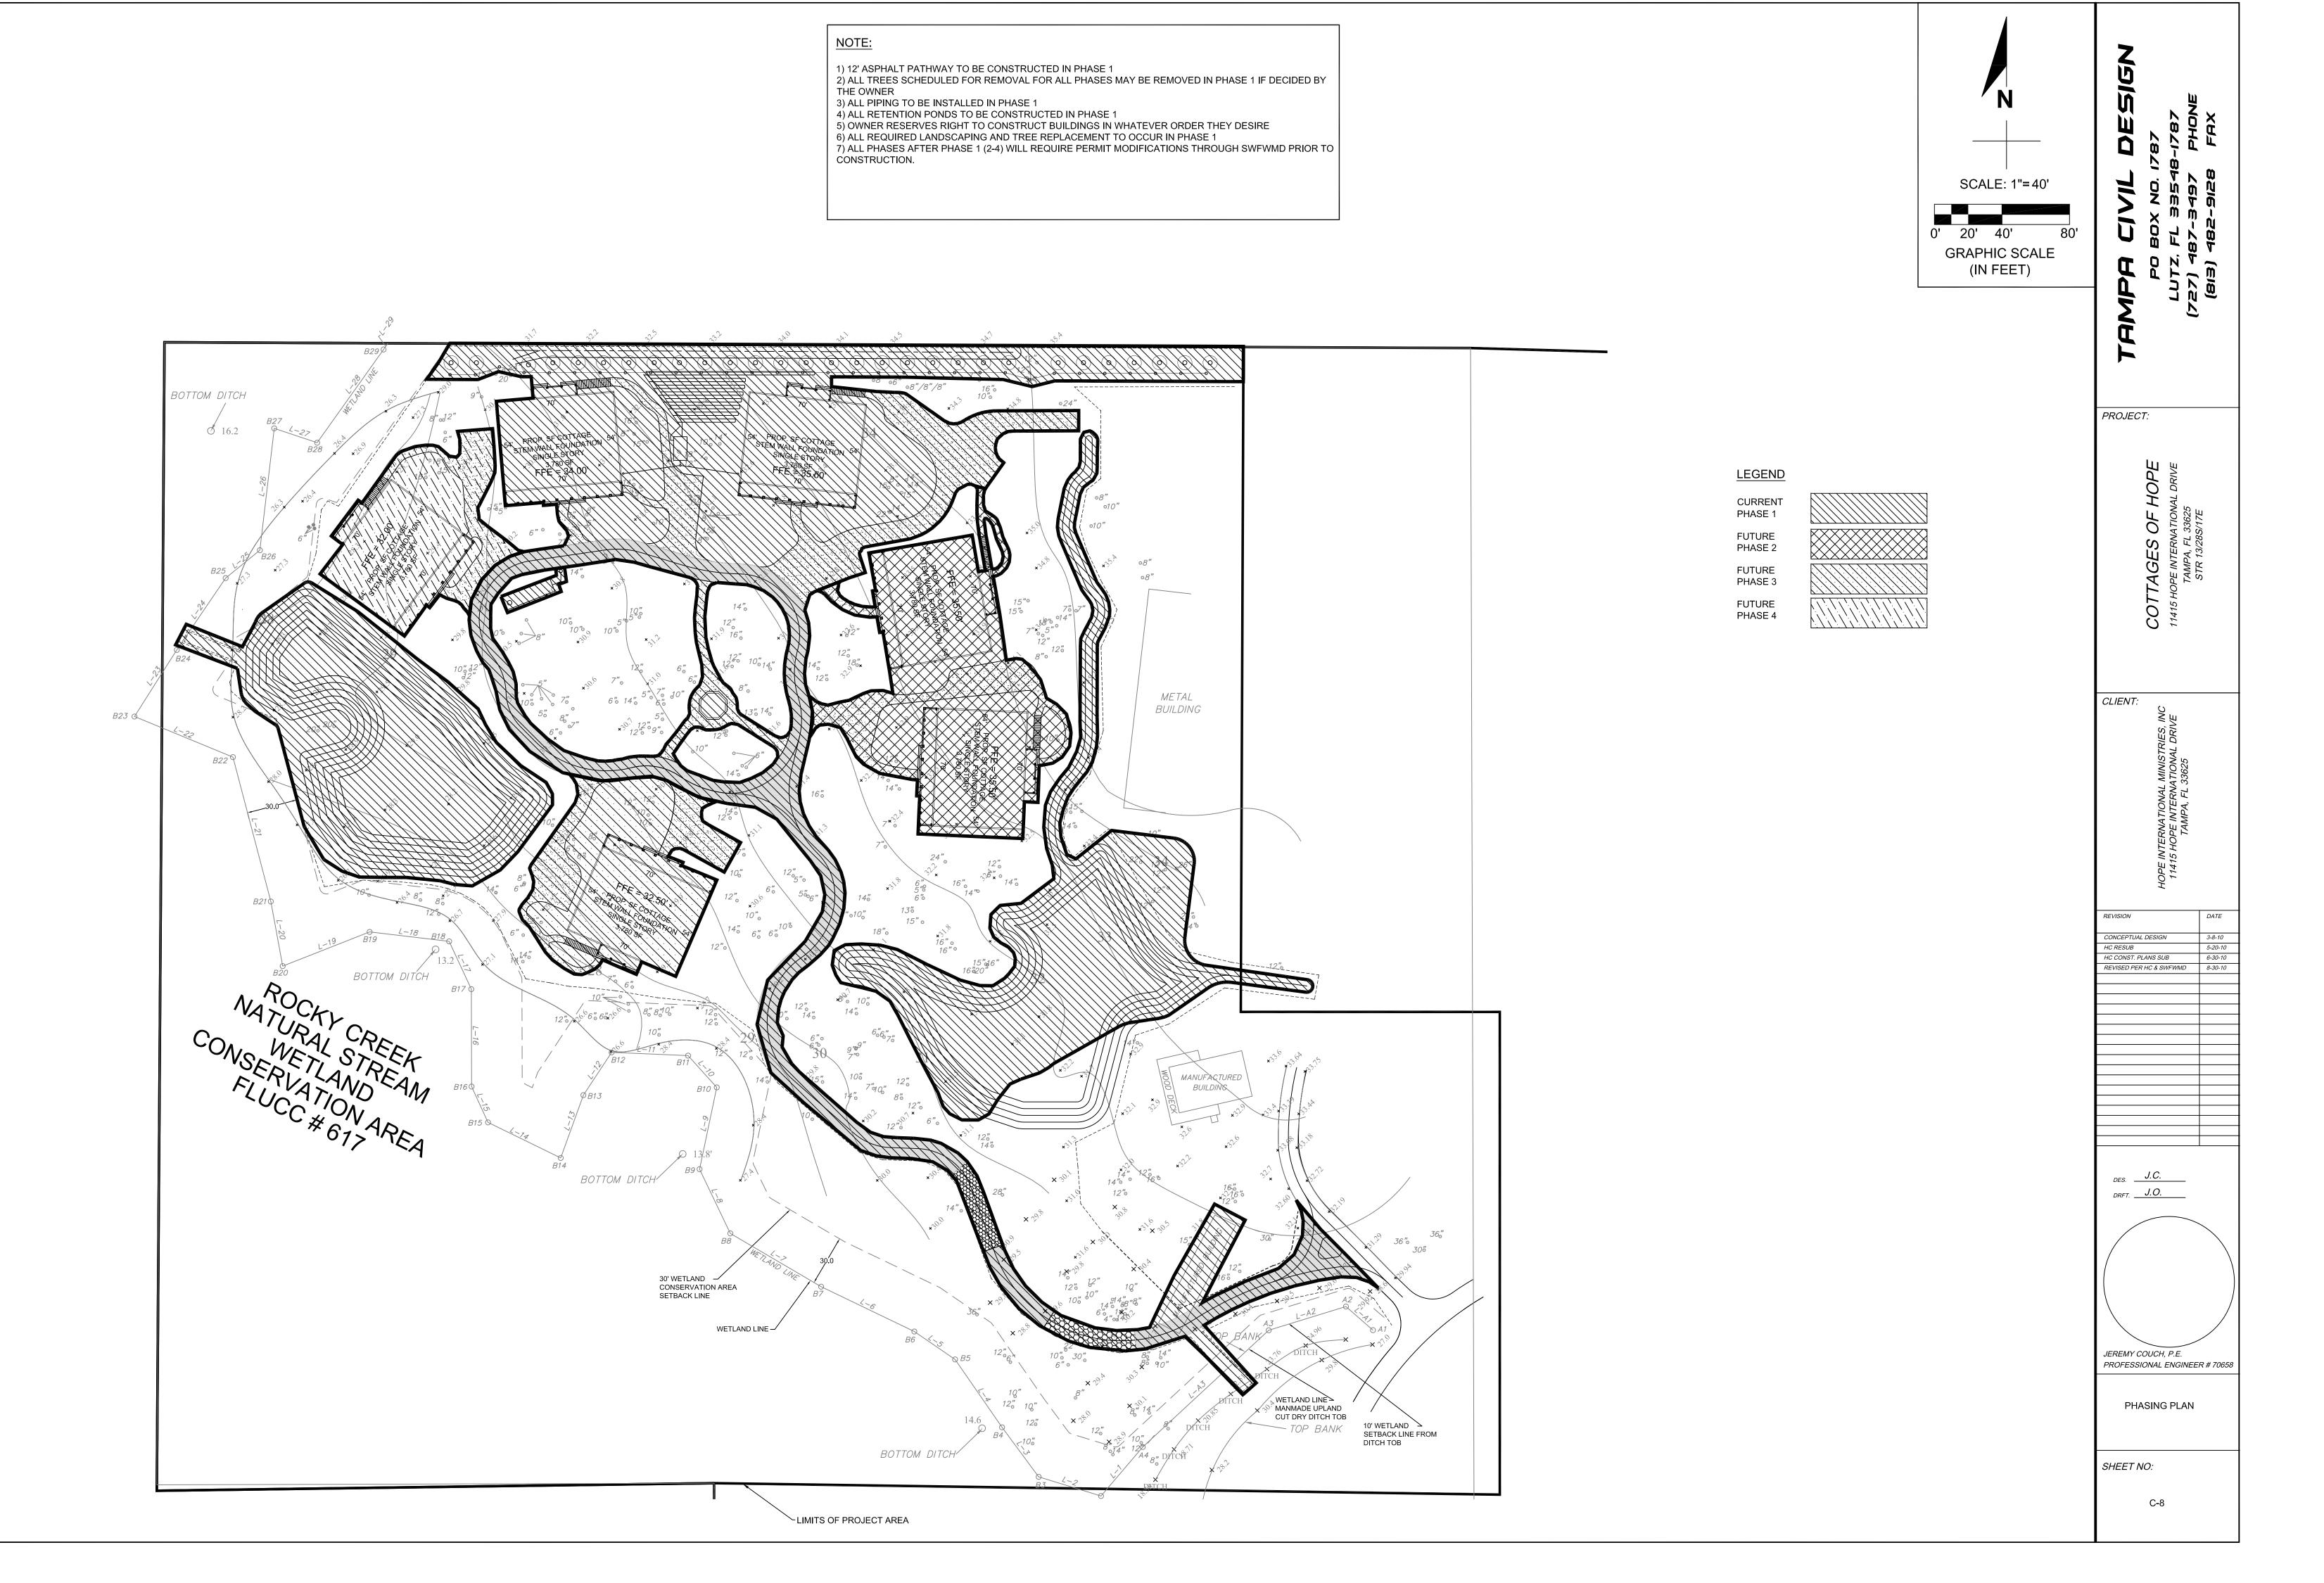


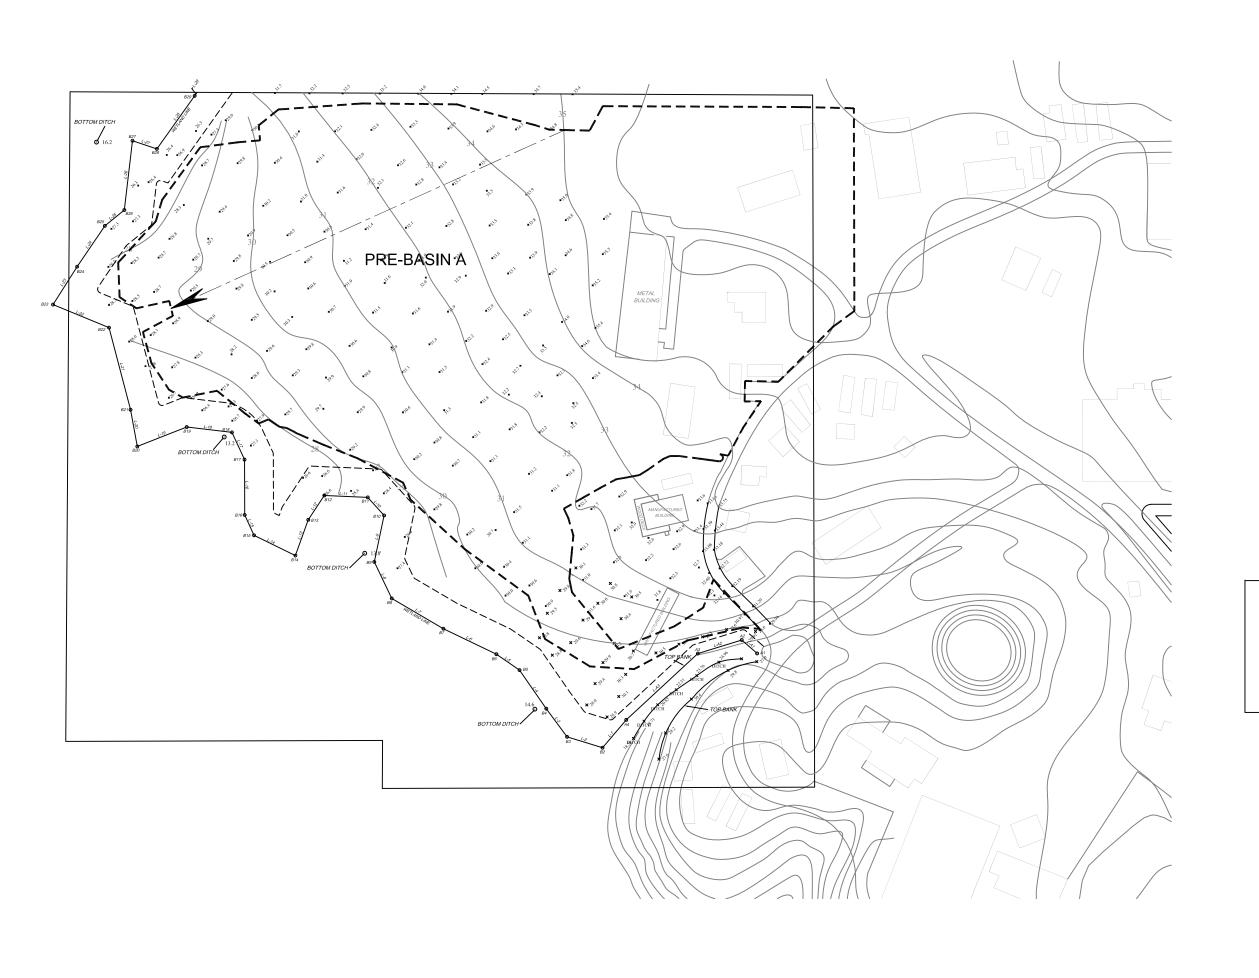

PRE-BASIN A
AREA = 6.12 AC
CN = 66.78
TC = 33.18 MIN

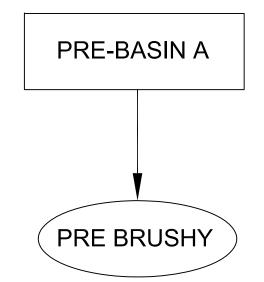

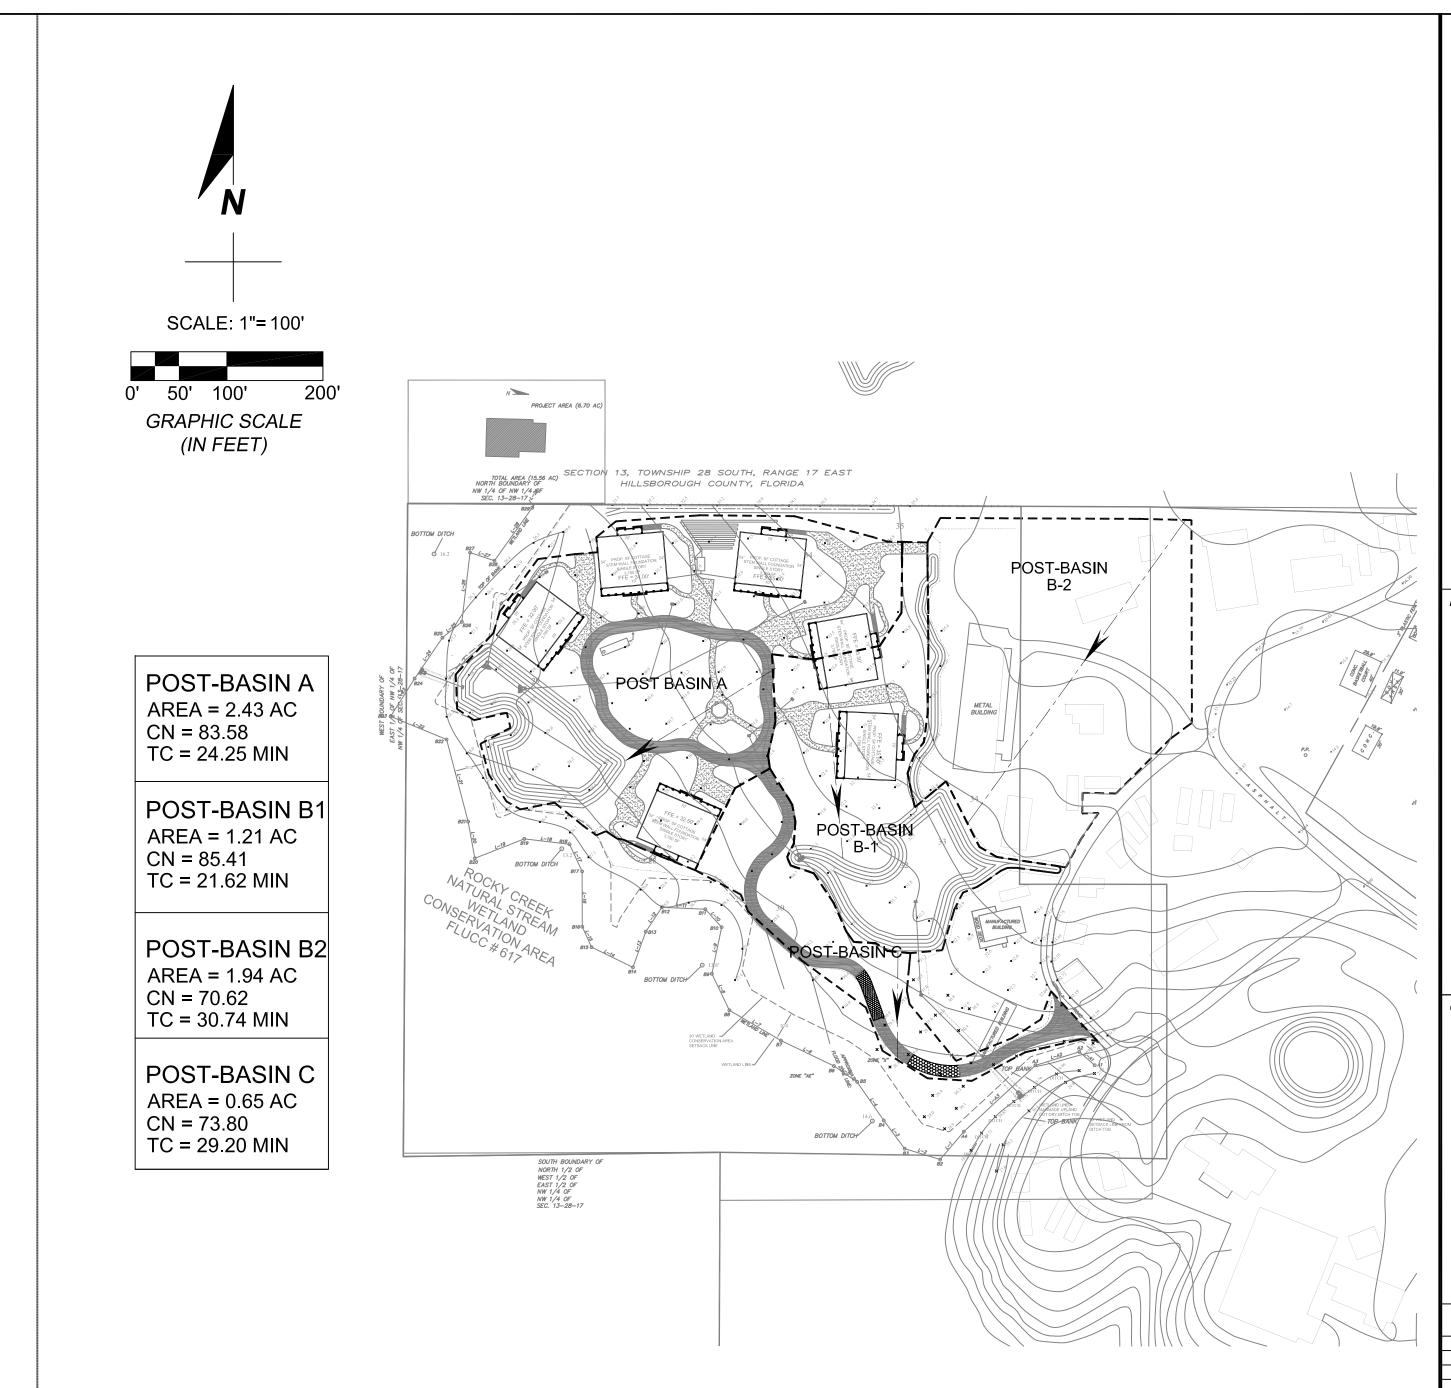

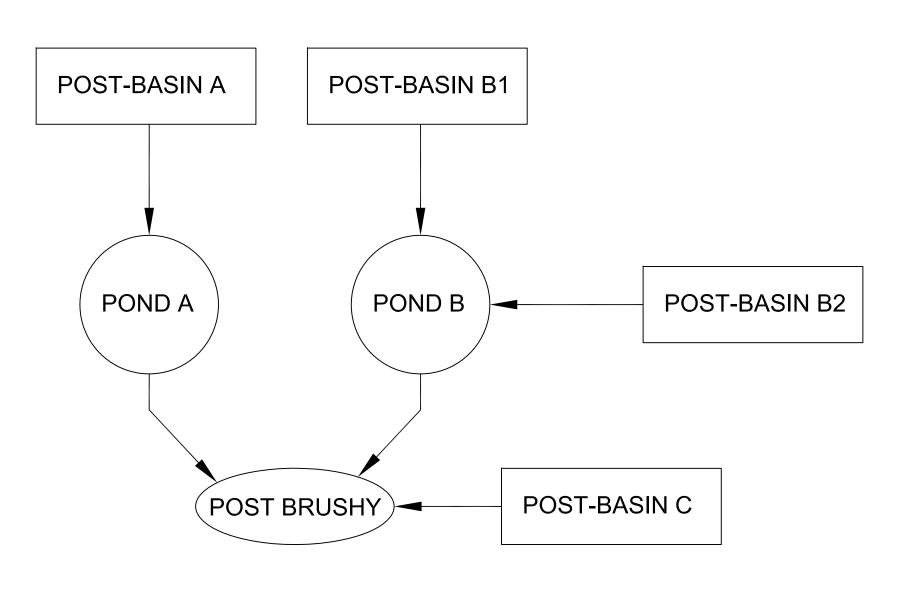

HMPH CIVIL DESIGN
PO BOX NO. 1787
LUTZ, FL 33548-1787
(727) 487-3497 PHONE

SES OF HOPE

INTERNATIONAL DRIVE

MPA, FL 33625

TR 1328S/17E

JATIONAL MINISTRIES, INC
AMPA, FL 33625

 REVISION
 DATE

 CONCEPTUAL DESIGN
 3-8-10

 HC RESUB
 5-20-10

 HC CONST. PLANS SUB
 6-30-10

 REVISED PER HC & SWFWMD
 8-30-10

 REVISED PER SWFWMD
 10-19-2010

DES. J.C.
DRFT. J.O.

JEREMY COUCH, P.E.
PROFESSIONAL ENGINEER # 70658

BASIN MAPS

SHEET NO:

C-9

